

Planning & Development Division

Planning & Economic Development Department



Room 160 411 West First Street Duluth, Minnesota 55802

File Number	PLSUP-2501-0015		Contact		Chris Lee, clee@duluthmn.gov			
Туре	Special Use Permit – Water Pumping Station		Planning Commission Da		Date		March 11, 2025	
Deadline for Action	Application Date		January 28, 2025		60 Days		March 29 2025	
	Date Extension Letter Mailed		February 14	February 14, 2025		S	May 28, 2025	
Location of Subject		408 N 34 th Ave E						
Applicant	City of D	City of Duluth						
Agent	Lakehead	akehead Constructors		Robert N	obert Mackereth			
Legal Description		PID: 010-2710-03610						
Site Visit Date		February 23, 2025	Sign Notice	Sign Notice Date		February 21, 2025		
Neighbor Letter Date		February 23, 2025	Number of	Number of Letters Sent		36		

Proposal

A Special Use Permit to construct a new structure to house a water pumping booster station for the City of Duluth.

Recommended Action: Approve with conditions.

	Current Zoning	Existing Land Use	Future Land Use Map Designation
Subject	R-1	Public Utilities	Traditional Neighborhood
North	R-1	Residential	Traditional Neighborhood
South	R-1	Public Utilities	Traditional Neighborhood
East	R-1	Residential	Traditional Neighborhood
West	R-1	Residential	Traditional Neighborhood

Summary of Code Requirements

UDC Section 50-37.10. Special Use Permits. The Planning Commission shall approve the application or approve it with modifications if the commission determines that the application meets the following criteria: 1. The application is consistent with the Comprehensive Land Use Plan; 2. The application complies with all applicable provisions of this Chapter, including without limitation any use-specific standards applicable to the proposed use, development or redevelopment, and is consistent with any approved district plan for the area; 3. Without limiting the previous criteria, the commission may deny any application that would result in a random pattern of development with little contiguity to existing or programmed development or would cause anticipated negative fiscal or environmental impacts on the community.

Comprehensive Plan Governing Principles and/or Policies and Current History (if applicable):

Governing Principle # 1- Reusing of previously developed lands: this proposal is utilizing existing developed lands for improved utilities resilience.

Governing Principle #12 - Create efficiencies in delivery of public services: this proposal is adding capacity to improve utility access for the City.

Future Land Use – Traditional Neighborhood: Characterized by grid or connected street pattern, houses oriented with shorter dimension to the street and detached garages, some with alleys. Limited commercial, schools, churches, and home businesses. Parks and open space areas are scattered through or adjacent to the neighborhood.

History: The property is currently a water pumping booster station that was constructed in 1914.

Review and Discussion Items

Staff finds that:

- 1. The applicant is proposing to construct a new 1,591 square foot water pumping booster station. The structure will be a single story with a maximum height at the parapet of 22 feet.
- 2. Th existing booster station will be demolished and the site of the old booster station will be restored to vegetation. As demonstrated with the governing principles above as well as the future land use of Traditional Neighborhood, this proposal meets the goals of the comprehensive plan.
- 3. UDC Sec. 50-24 (Parking and loading). The site plan indicates a parking pad that can accommodate 3 vehicles.
- 4. UDC Sec. 50-25 (Landscaping and Tree Preservation). The applicant is not proposing any trees or shrubs as there is extensive underground infrastructure. The disturbed soils and removed structure will be replaced with grass.
- 5. UDC Sec. 50-26 (Screening, Walls and Fences). No commercial containers or fencing is being installed. The plans indicate the rooftop vents will be screened with parapets and not be visible from the street.
- 6. UDC Sec. 50-29 (Sustainability Standards). Does not apply as the structure is under 10,000 square feet.
- 7. UDC Sec. 50-30 (Building Design Standards). The proposed structure meets these requirements for wall articulations, roof design, and glazing.
- 8. UDC Sec. 50-31 (Exterior Lighting). Building mounted LED lighting appears to be appropriate with downcast fixtures. This will be verified at the time of building permit application.
- 9. As demonstrated by the above findings, this proposal meets all application provisions of the UDC.
- 10. The proposed pump house will not result in a random pattern of development or have anticipated negative fiscal or environmental impacts.
- 11. No City, agency, or public comments have been received.
- 12. Per UDC 50-37.1.N, an approved Planning Review will expire if the project or activity authorized is not begun within one year, which may be extended for one additional year at the discretion of the Land Use Supervisor.


Staff Recommendation

Based on the above findings, staff recommends that Planning Commission approve the Special Use Permit with the following conditions:

- 1. The project be limited, constructed, and maintained consistent with plans submitted and included in this report.
- 2. Exterior lighting will meet all zoning requirements; applicant shall provide a lighting plan at the time of building permit application to confirm compliance with these requirements.
- 3. Any alterations to the approved plans that do not alter major elements of the plan may be approved by the Land Use Supervisor without further Planning Commission approval; however, no such administrative approval shall constitute a variance from the provisions of Chapter 50.



PLSUP-2501-0015 Special Use Permit 3405 E 4th St

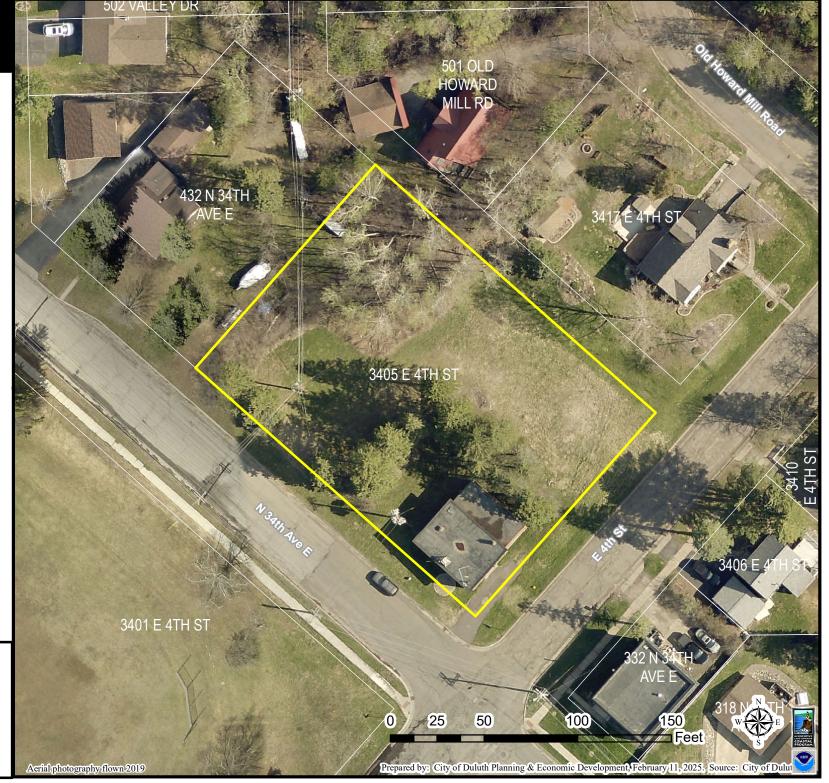

The City of Duluth has tried to ensure that the information contained in this map or electronic document is accurate. The City of Duluth makes no warranty or guarantee concerning the accuracy or reliability. This drawing/data is neither a legally recorded map nor a survey and is not intended to be used as one. The drawing/data is a compilation of records, information and data located in various City, County and State offices and other sources affecting the area shown and is to be used for reference purposes only. The City of Duluth shall not be liable for errors contained within this data provided or for any damages in connection with the use of this information contained within.

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NOTES:

1. THESE IMAGES ARE CONCEPTUAL AND FOR GENERAL REFERENCE - SEE DRAWINGS FOR ALL DESIGN AND DETAILING.

2. FINAL COLOR SELECTION TO BE DETERMINED.

PROJECT DATE: FEBRUARY 26, 2024 DRAWN BY: MAMUFO
DESIGNED BY: AJS
CHECKED BY: Checker



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WOODLAND BOOSTER STATION IMPROVEMENTS CITY OF DULUTH ST. LOUIS COUNTY, MINNESOTA

BOOSTER STATION - ARCHITECTURAL PERSPECTIVE


00616177 SHEET 30-A100

GENERAL NOTES

- A. ALL DIMENSIONING IS TO FACE OF CONCRETE MASONRY UNIT OR CONCRETE.
- B. DO NOT SCALE DRAWINGS. IF DIMENSIONS ARE IN QUESTION, THE CONTRACTOR SHALL BE RESPONSIBLE FOR OBTAINING CLARIFICATION FROM THE ARCHITECT BEFORE CONTINUING WITH CONSTRUCTION.
- C. THE CONTRACT DOCUMENTS CONSIST OF THE SPECIFICATION MANUAL AND DRAWINGS WHICH ARE INTENDED TO BE COMPLEMENTARY AND TO BE USED IN CONJUNCTION WITH ONE ANOTHER.
- D. IF DISCREPANCIES OCCUR BETWEEN THE SPECIFICATION MANUAL AND THE DRAWINGS, NOTIFY THE ARCHITECT FOR A RESOLUTION.
- E. EXTERIOR WALL AND RELATED OPENINGS BY ALL TRADES SHALL BE FLASHED AND CAULKED BY THE GC. ALL ROOFING PENETRATIONS SHALL BE FLASHED BY THE ROOFING CONTRACTOR.
- F. OPENINGS FOR PLUMBING, PROCESS, VENTILATING, AND ELECTRICAL WORK IN WALLS, FLOORS, CEILINGS, AND ROOF SHALL BE PROVIDED BY THE GC. LOCATION AND SIZE SHALL BE THE RESPONSIBILITY OF THE RESPECTIVE CONTRACTORS.
- G. CONTRACTOR TO COORDINATE STRUCTURAL, ARCHITECTURAL, HVAC, AND PLUMBING PLANS FOR DETAILS, DIMENSIONS, ELEVATIONS, OPENINGS, INSERTS, ETC. NOTIFY ARCHITECT OF ANY VARIANCE BEFORE COMMENCING CONSTRUCTION
- H. IN NO CASE SHALL STRUCTURAL ALTERATIONS OR WORK AFFECTING A STRUCTURAL MEMBER BE MADE, UNLESS APPROVED BY THE ENGINEER.
- I. GENERAL CONTRACTOR SHALL PROVIDE ALL CONCRETE EQUIPMENT HOUSEKEEPING PADS INSIDE THE BUILDING AS INDICATED ON THE PLUMBING, PROCESS MECHANICAL, HVAC, AND ELECTRICAL DRAWINGS.
- J. ALL PIPE AND CONDUIT PENETRATIONS THROUGH EXTERIOR WALLS SHALL BE PER DETAIL 2/30-A503. CONDUIT MAY BE GROUTED SOLID IN LIEU OF PERIMETER SEALANT. PIPES SHALL BE SEALED ON BOTH SIDES.
- K. ALL NEW EXPOSED ANCHORS, PIPING, CONDUIT, DUCTWORK, INSULATION (WITHOUT FINISHED JACKET), HANGERS, BRACKETS, SUPPORTS, FASTENERS, ETC, SHALL BE PAINTED, INTERIOR AND EXTERIOR, UNO.

KEY NOTES

- 1 ELECTRICAL PANEL LOCATION SEE ELECTRICAL
- 2 PROCESS EQUIPMENT OR PIPING, TYP SEE PROCESS MECHANICAL
- 3 CONCRETE STOOP SEE FOUNDATION PLAN
- 4 1/2" EXPANSION JOINT MATERIALS W/ REMOVABLE CAP AND SELD-LEVELING SEALANT BETWEEN SIDWALK, BUILDING AND STOOP FOUNDATION, TYP
- 5 TRENCH DRAIN SEE PLUMBING
- 6 3 1/2" HIGH CONCRETE HOUSEKEEPING PAD BY GC FOR ELECTRICAL EQUIPMENT. PROVIDE 6x6-W2.9xW2.9 WWM AND RADIUS TOOLED EXPOSED EDGES. PAD TO BE 4" BEYOND FACE AND EXPOSED END OF ELECTRICAL EQUIPMENT, UNO. VERIFY FINAL SIZE REQUIRED W/ ELECTRICAL
- 7 ROOF ACCESS LADDER SEE DETAIL 3/30-A503
- 8 GUARDRAIL w/ TOE PLATE SEE DETAIL 9/30-A503
- 9 WALL MOUNTED HANDRAIL SEE DETAIL 7/30-A503
- 10 STEEL STAIR SEE DETAIL 6/30-A503
- 11 CONCRETE SIDEWALK W/ BROOM FINISH AND TOOLED CONTROL JOINTS AS SHOWN OVER MIN 6" COMPACTED GRANULAR FILL. SLOPE AWAY FROM BUILDING, CROSS SLOPE MAX 1:50. RUNNING SLOPE MAX 1:20. SEE SITE/CIVIL
- 12 GUARDRAIL w/ HANDRAIL SEE DETAIL 8/30-A503
- 13 RAISED CONCRETE EQUIPMENT PAD SEE PRECESS MECHANICAL AND STRUCTURAL
- 14 TOP MOUNTED HANDRAIL SEE SHEET 05-C511
- 15 PIPE BOLLARD SEE SITE/CIVIL
- 16 PAINT ALL INTERIOR CMU WALLS FULL HEIGHT
- 17 PAINT CONCRETE WALL FULL HEIGHT WALL TO WALL
- 18 MASONRY OPENING FOR LOUVER SEE DETAIL 9/30-A502
- 19 PAINT ENTIRE EXPOSED UNDERSIDE OF ROOF STRUCTURE INCLUDING STEEL JOISTS, METAL DECK AND MISC FRAMING AND BRIDGING COMPLETE.
- 20 WALL MOUNTED TACTILE "EXIT" SIGN SEE DETAIL 1/30-A503
- 21 FIRE EXTINGUISHER w/ WALL BRACKET, TOP AT 48" AFF

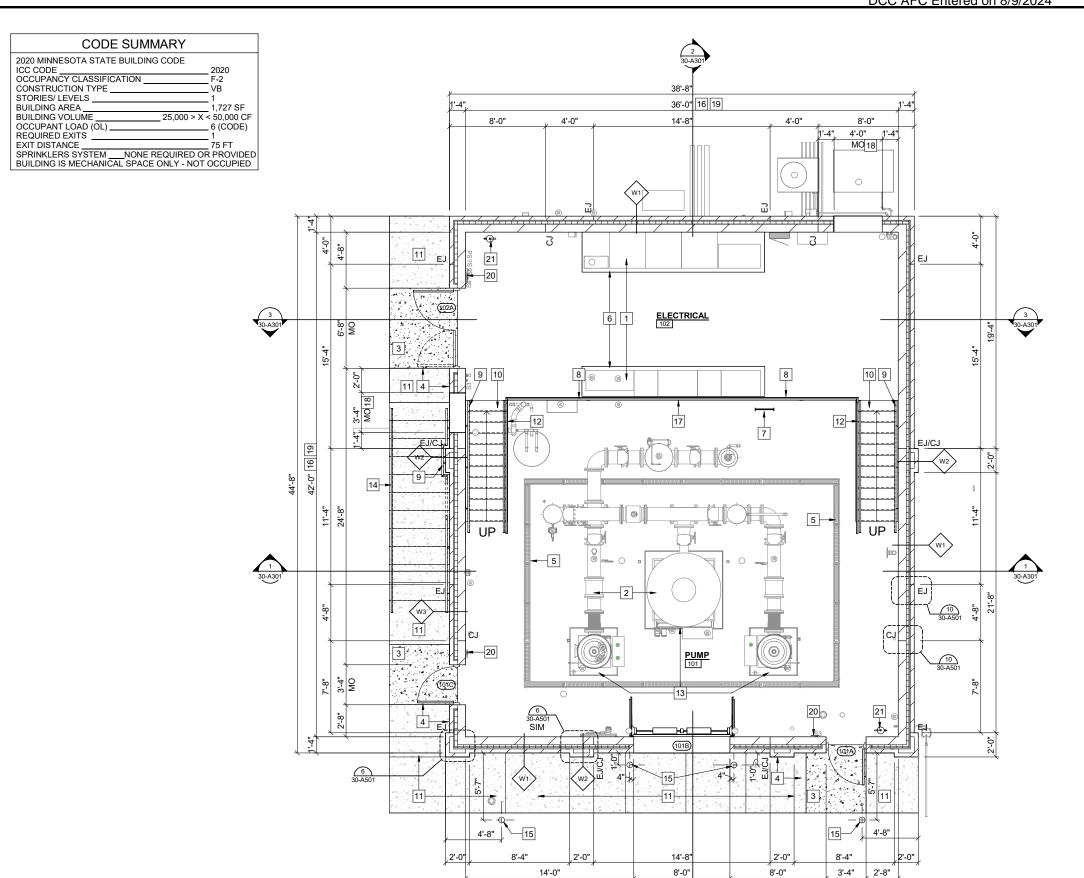

PROJECT DATE: FEBRUARY 26, 2024 DRAWN BY: MAMUJFG DESIGNAE DBY: AJS CHECKED BY: SC CHECKED BY: S

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DULUTH NORTH

1

FLOOR PLAN

1/4" = 1'-0" (22"x34") 1/8" = 1'-0" (11"x17")

WOODLAND BOOSTER STATION IMPROVEMENTS
CITY OF DULUTH
ST. LOUIS COUNTY, MINNESOTA

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BOOSTER STATION - ARCHITECTURAL FLOOR PLAN

PROJECT NO. 00616177

SHEET 30-A101

8202 Distribution: RK DCC AFC Entered on 8/9/2024 ..3.. EJ/CJ EJ/CJ \bigcirc 4'-0" CITY OF DULUTH NORTH CLEARSTORY PLAN


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1/8" = 1'-0" (11"x17") ENGINEERING | ARCHITECTURE | SURVEYING FUNDING | PLANNING | ENVIRONMENTAL 332 W Superior St, Ste 600, Dulluth MN 55802 (218) 722-3915 www.msa-ps.com PROJECT DATE: FEBRUARY 26, 2024 DRAWN BY: MAMUFG
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CHECKED BY: SC WOODLAND BOOSTER STATION IMPROVEMENTS **BOOSTER STATION - ARCHITECTURAL** 00616177 CITY OF DULUTH SHEET **CLEARSTORY PLAN** ST. LOUIS COUNTY, MINNESOTA 30-A102


KEY NOTES

- 1 PREFINISHED ROOF EDGE/FASCIA, TYP
- 2 OVERFLOW ROOF DRAIN SEE DETAIL 3/30-A501
- 3 ROOF DRAIN SEE DETAIL 3/30-A501
- 4 ROOF SADDLE 1/2 INCH PER FOOT TAPERED ISO INSULATION WITH 1/2 INCH EDGE THICKNESS, TYP BY ROOFING CONTRACTOR
- 5 WALKING PAD BY ROOFING MANUFACTURER, TYP
- 6 EQUIPMENT ACCESS HATCH, SHALL BE CENTERED OVER PUMPS AND TANK SEE DETAIL 2/30-A501 SIM
- 7 ROOF ACCESS HATCH SEE DETAIL 2/30-A501
- 8 METAL FASCIA END CAP
- 9 PREFINISHED METAL FASCIA TO WRAP PARAPET SEE DETAIL 7/30-A501

FULLY ADHERED MEMBRANE ROOFING SYSTEM

- FULLY ADHERED 60 MIL EPDM MEMBRANE ROOF SYSTEM
- 2 INCH FLAT POLYISO INSULATION BOARD
- 1/4 INCH PER FOOT FOUR WAY TAPERED POLYISO INSULATION WITH 1/2 INCH EDGE THICKNESS AT THE RD
- 2 INCH FLAT POLYISO INSULATION BOARD
- VAPOR RETARDER
- STEEL ROOF DECK SEE STRUCTURAL

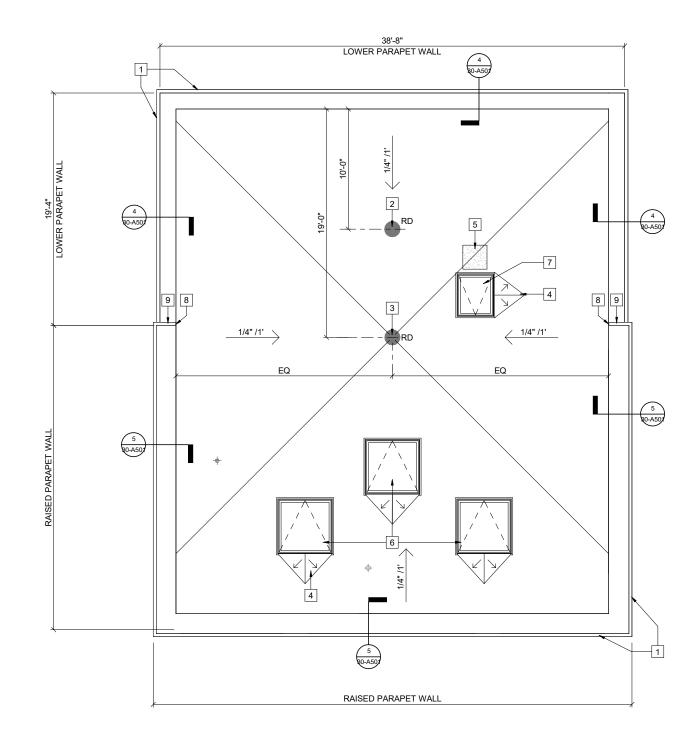

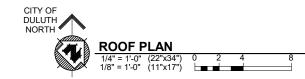



PROJECT DATE: FEBRUARY 26, 2024 DRAWN BY: MAMUFG DESIGNED BY: AJS CHEER DESIGNED BY: AJS CHEER DESIGNED BY: Checker CHEER DESIGNED BY: CHEER DESIGN



ENGINEERING | ARCHITECTURE | SURVEYING FUNDING | PLANNING | ENVIRONMENTAL 332 W Superior St, Ste 600, Duluth MN 55802 (218) 722-3915 www.msa-ps.com WOODLAND BOOSTER STATION IMPROVEMENTS
CITY OF DULUTH
ST. LOUIS COUNTY, MINNESOTA


BOOSTER STATION - ARCHITECTURAL ROOF PLAN PROJECT NO. 00616177
SHEET 30-A103


KEY NOTES

- 1 4" HIGH BRICK TYPE A, 4"x4"x16"
- 2 8" HIGH BRICK TYPE B, 4"x8"x16"
- 3 8" HIGH BRICK TYPE C, 4"x8"x16"
- 4 PREFINISHED ROOF EDGE/FASCIA, TYP
- 5 8" HIGH LETTERS CENTER IN BRICK ABOVE OVERHEAD DOOR
- 6 CAST STONE SILL, TYP
- 6" HIGH ADDRESS NUMBERS VERIFY FINAL NUMBER WITH OWNER CENTER ABOVE WALK DOOR
- 8 PREFINISHED LOUVER SEE HVAC
- 9 PAINT EXPOSED CMU
- 10 EXTENT OF SHEET MEMBRANE WATER PROOFING
- 11 PREFINISHED LIGHT FIXTURE, TYP SEE ELECTRICAL. MOUNT CENTER OF LIGHT AT 8'-8" AFF, CENTERED OVER DOOR
- 12 PREFINISHED LIGHT FIXTURE, TYP SEE ELECTRICAL. MOUNT CENTER OF LIGHT AT 8'-8" AFF, CENTERED BELOW WINDOW
- 13 PREFINISHED LIGHT FIXTURE, TYP SEE ELECTRICAL. MOUNT CENTER OF LIGHT AT 13'-6" AFF, CENTERED ON PIER
- 14 PREFINISHED LIGHT FIXTURE, TYP SEE ELECTRICAL. MOUNT CENTER OF LIGHT AT 19'-8" AFF, CENTERED BETWEEN PIERS
- 15 PREFINISHED LIGHT FIXTURE, TYP SEE ELECTRICAL. MOUNT CENTER OF LIGHT AT 8'-10" AFF, CENTER ON WALL
- 16 PREFINISHED LIGHT FIXTURE, TYP SEE ELECTRICAL. MOUNT CENTER OF
- LIGHT AT 8'-10" AFF

 17 DEDICATION PLAQUE FURNISHED BY OWNER. INSTALLED BY CONTRACTOR.
- 18 ANTENNA, PIPE MAST, MOUNTING BRACKETS AND CABLE BY ELECTRICAL -
- SEE ELECTRICAL. PAINT PIPE AND BRACKETS, TYP

 19 PIPE BOLLARD SEE SITE/CIVIL. PAINT, TYP
- 20 GAS METER AND PIPING PAINT
- 21 SEE DETAIL 11/30-A503 FOR MASONRY LAYOUT AT PIERS AND CORNER PIERS.

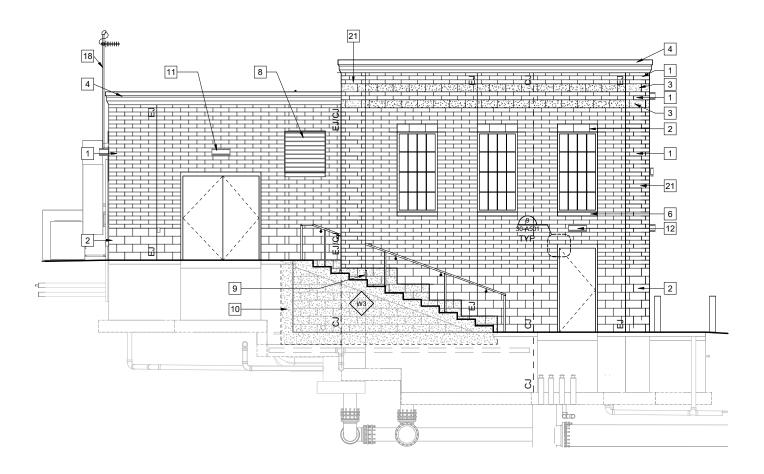

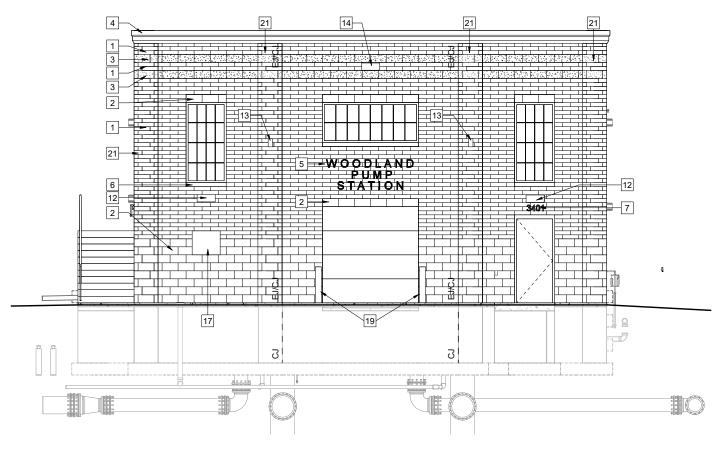

WEST EXTERIOR BUILDING ELEVATION

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WOODLAND BOOSTER STATION IMPROVEMENTS

SOUTH EXTERIOR BUILDING ELEVATION

CITY OF DULUTH
ST. LOUIS COUNTY, MINNESOTA

BOOSTER STATION - ARCHITECTURAL EXTERIOR ELEVATIONS


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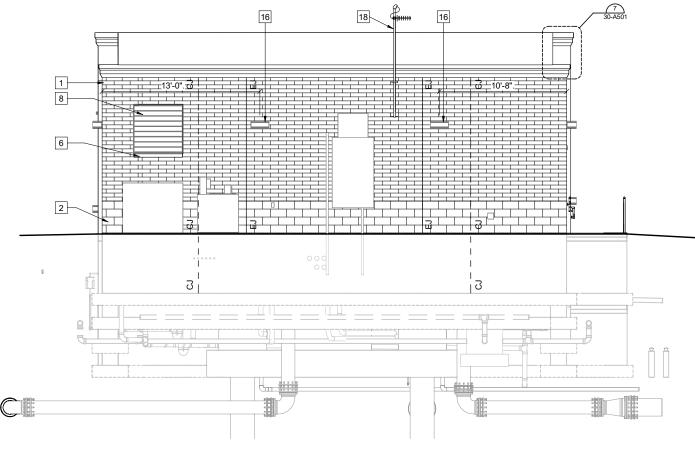
PROJECT NO. 00616177 SHEET 30-A201

KEY NOTES

- 1 4" HIGH BRICK TYPE A, 4"x4"x16"
- 2 8" HIGH BRICK TYPE B, 4"x8"x16"
- 3 8" HIGH BRICK TYPE C, 4"x8"x16"
- 4 PREFINISHED ROOF EDGE/FASCIA, TYP
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- 6 CAST STONE SILL, TYPE
- $7\,$ $\,$ 6" HIGH ADDRESS NUMBERS VERIFY FINAL NUMBER WITH OWNER CENTER ABOVE WALK DOOR $\,$
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EAST EXTERIOR BUILDING ELEVATION

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OJECT DATE: FEBRUARY 26, 2024 DRAWN BY: MAMUFG
DESIGNED BY: AJS
DESIGNED BY: AJS
OTHER THAT THIS PLAN REPORT, OR SPECIFICATION WAS PREPARED BY ME OR UNDER MY DIRECT SUPERVISION
D THAT I AM A DULY LICENSED PROFESSIONAL ENGINEER UNDER THE LAWS OF THE STATE OF MINNESOTA.
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1/8" = 1'-0" (11"x17")

NORTH EXTERIOR BUILDING ELEVATION

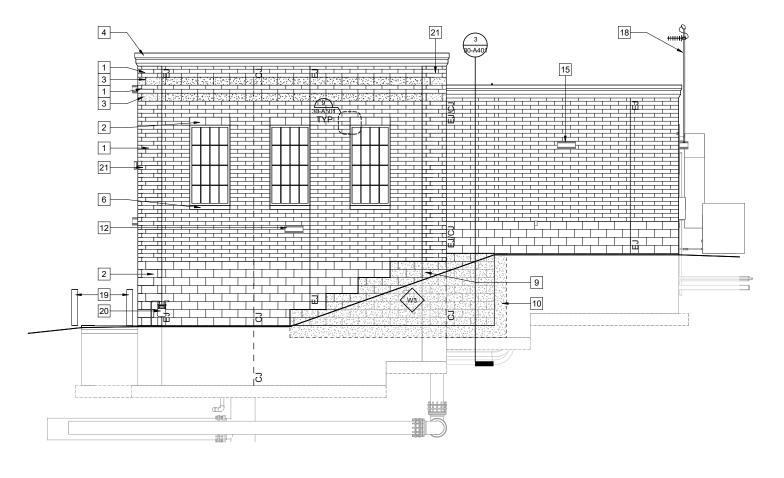WOODLAND BOOSTER STATION IMPROVEMENTS
CITY OF DULUTH
ST. LOUIS COUNTY, MINNESOTA

BOOSTER STATION - ARCHITECTURAL EXTERIOR ELEVATIONS

PROJECT NO. 00616177 SHEET 30-A202


8202 Distribution: RK DCC AFC Entered on 8/9/2024 TOP OF MASONRY OP OF MASONRY TOP OF OPP HD MASONRY JOIST BEARING JOIST BEARING JOIST BEARING UPPER LEVEL UPPER LEVEL W3 MAIN LEVEL 870' - 6" MAIN LEVÈ MAIN LEVEL 870' -- 6"-870' - 6" WRAP SHEET MEMBRANE WATERPROOFING UP FULL HEIGHT OF WALL, WALL TO WALL, TERMINATE TOP EDGE OF WATERPROOFING w/ CONT TERM BAR AND A CONT BEAD ----INSTALL 2 INCH BOARD INSULATION OVER THE ENTIRE 6" COMPACTED GRAVEL FILL, TYP TYPICAL EXCAVATION UNDER CONCRETE FLOOR PAINT EXPOSED CONCRETE WALL FULL HEIGHT, WALL TO WALL. SLABS 2' BELOW BOTTOM OF SLAB OR DEEPER IF COMPACTED GRANULAR FILL, TYP WALL FULL HEIGHT AND WIDTH NEEDED TO REMOVE TOP SOIL **BUILDING SECTION BUILDING SECTION** 30-A301 1/4" = 1'-0" (22" x 34") 0 2 30-A301 1/4" = 1'-0" (22" x 34") 0 2 1/8" = 1'-0" (11" x 17") 1/8" = 1'-0" (11" x 17") PAINT ALL EXPOSED SURACES OF THE JOISTS AND DECK ENTIRE BUILDING TOP OF 30-A401 OPP HD MASONRY (JOIST BEARING UPPER LEVEL **3** BUILDING SECTION 30-A301 1/4" = 1'-0" (22" x 34") 0 2 1/8" = 1'-0" (11" x 17") ENGINEERING | ARCHITECTURE | SURVEYING FUNDING | PLANNING | ENVIRONMENTAL **WOODLAND BOOSTER STATION IMPROVEMENTS** PROJECT DATE: FEBRUARY 26, 2024 DRAWN BY: MAM/JFG **BOOSTER STATION - ARCHITECTURAL** 00616177 FUNDING | PLANNING | ENVIRONMENTAL
332 W Superior St, Ste 600, Duluth MN 55802
(218) 722-3915 www.msa-ps.com CITY OF DULUTH CHECKED BY: Checker **BUILDING SECTIONS** SHEET EREBY CERTIFY THAT THIS PLAN. REPORT, OR SPECIFICATION WAS PREPARED BY ME OR UNDER MY DIRECT SUPERVISION DATE FEBRUARY 28, 2024

THAT I AM A DULY LICENSED PROFESSIONAL ENGINEER UNDER THE LAWS OF THE STATE OF MINNESOTA.


DATE FEBRUARY 28, 2024

ENGINEER ALLEN J. SZYMANSKI. ST. LOUIS COUNTY, MINNESOTA 30-A301


8202 Distribution: RK DCC AFC Entered on 8/9/2024

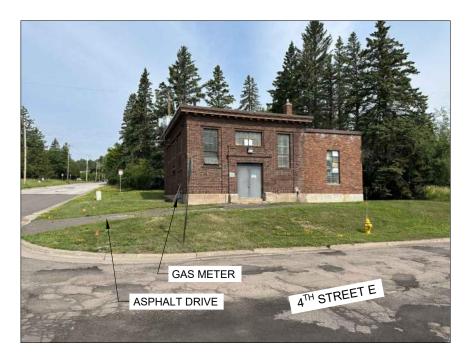

1 EXTERIOR WALL LOOKING NORTH 05-CG101 NO SCALE

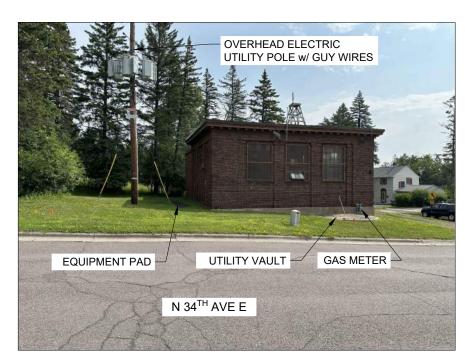

2 EXTERIOR WALL LOOKING EAST 05-CG101 NO SCALE

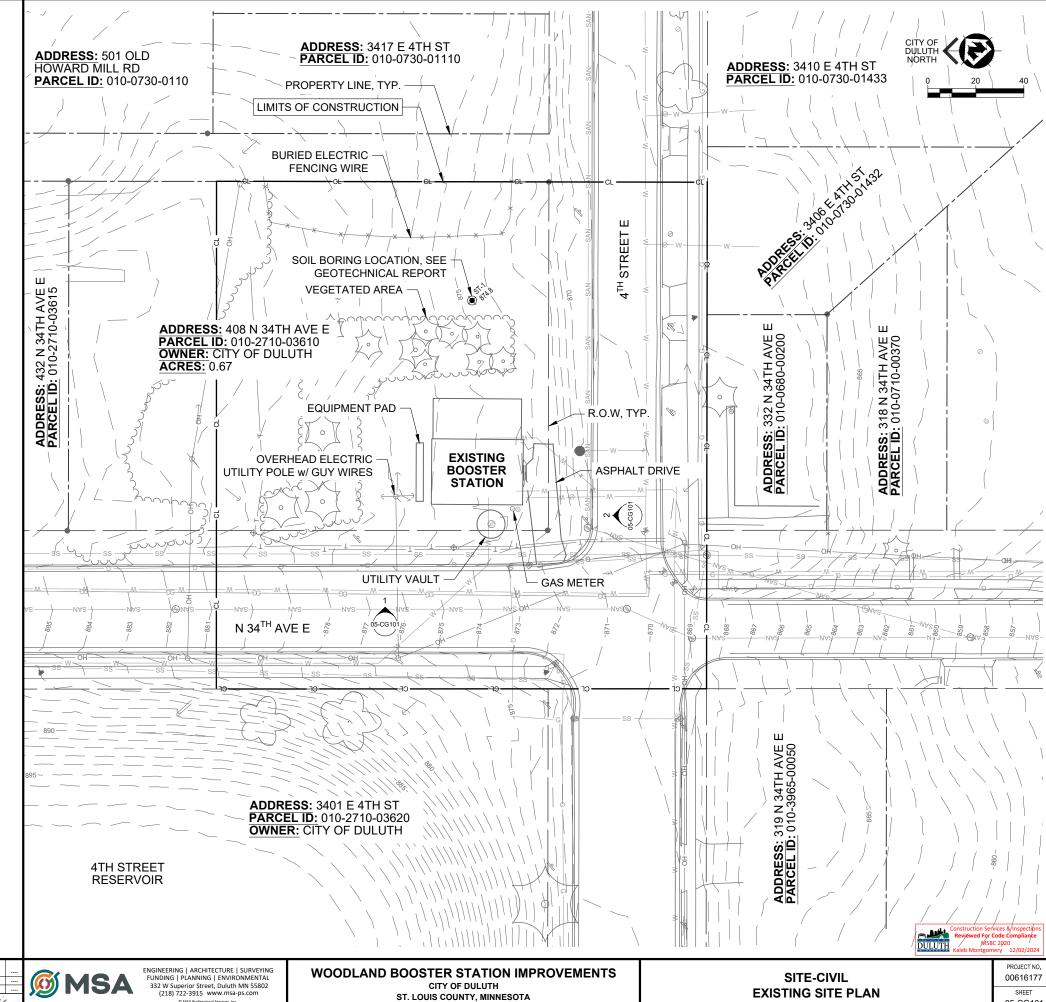

ROJECT DATE: FEBRUARY 26, 2024 DRAWN BY: DESIGNED BY DESIGNED BY: JL ---- ---CHECKED BY: SRC ---- ----Y CERTIFY THAT THIS PLAN, REPORT, OR SPECIFICATION WAS PREPARED BY ME OR UNDER MY DIRECT SUPERVISION
AT I AM A DULY LICENSED PROFESSIONAL ENGINEER UNDER THE LAWS OF THE STATE OF MINNESOTA.

DATE: February 26, 2024 Sor R Cli

05-CG101

8202 Distribution: RK DCC AFC Entered on 8/9/2024 KEY NOTES # 28 37 6 15 PROTECT EXISTING 10" COATED STEEL GAS MAIN 1.1 DEMO EXISTING 90° BEND T.O.P. = 862.54 25 16 PROTECT EXISTING LOW PRESSURE GAS LINE 1.2 PROVIDE 20"X20"X20" MJ TEE 1.4 T.O.P. = 862.71 17 PROTECT EXISTING 15" CLAY SANITARY SEWER MAIN 1.3 PROVIDE 20" ROMAC COUPLING 18 PROTECT EXISTING 15" RC STORM SEWER MAIN 1.4 20" DIP 9+33.96-PROPOSED WOODLAND **BOOSTER STATION** 19 PROTECT EXISTING 8" CLAY SANITARY SEWER MAIN 1.5 PROVIDE 20" MJ BUTTERFLY VALVE W/ VALVE BOX UPPER LEVEL FFE = 876.50 22 MAIN LEVEL FFE = 870.50 9 1.5 20 PROVIDE 20"X20"X16" MJ TEE 2 PROVIDE 20" MJ 45° BEND PROTECT OVERHEAD POWER LINES - COORDINATE INLET 21 WITH UTILITIES 3 PROVIDE 20" MJ WYE T.O.P. = 862.71 T.O.P. = 862.54 34 33 4 PROVIDE 20"X12" MJ REDUCER 22 16" DIP 36 DISCHARGE 23 32 11 5 12" DIP 23 PROVIDE 16"X12" MJ REDUCER 12 T.O.P. = 862.7 6 PROVIDE 12" MJ 45° BEND 24 PROVIDE 16" BUTTERFLY VALVE W/ VALVE BOX 8 13.3 PROVIDE 12" MJ 90° BEND 25 PROVIDE 12" BUTTERFLY VALVE W/ VALVE BOX 13.2 24 13.1 24 PROVIDE 16" MJ 90° BEND 26 ANODE BANK 35 T.O.P. = 871.67 19 T.O.P. = 862.71 E 4TH STREET 9 PROVIDE 20"X16" MJ REDUCER 27 PROVIDE HYDRANT W/ GATE VALVE & VALVE BOX 22 10 TIE INTO EXISTING WATERMAIN 28 PROVIDE 12"X12"X6" MJ TEE 11 6" C900 PVC SANITARY LATERAL 29 PROVIDE 16"X16"X6" MJ TEE 2 PROVIDE UTILITY CONNECTION TO SOUTH GRID 12 PROVIDE 2-WAY SANITARY CLEANOUT SOURCE - COORDINATE WITH MINNESOTA POWER TIE INTO EXISTING 8" SANITARY SEWER MAIN 13.1 WITH 6"X8" PVC WYE PROVIDE UTILITY CONNECTION TO NORTH GRID 1.4 SOURCE - COORDINATE WITH MINNESOTA POWER **EXISTING** 1.5 13.2 CLAY TO PVC CONNECTION COUPLING (2 - REQ'D) WOODLAND 32 PROVIDE 1" CORPORATION IN WATERMAIN **BOOSTER** 1.3 13.3 8" C900 PVC SANITARY PIPE 33 PROVIDE 1" POLYETHYLENE WATER SERVICE 14 PROTECT EXISTING 8" CAST IRON WATER MAIN 34 PROVIDE 1" CURBSTOP 1.1 & 1.2 29 35 SHEET 05-C101 600 4"Ø HDPE STORMWATER EJECTOR FORCE MAIN - SHEET 1.4 27 1.3 DRAIN TILE STORMWATER EJECTOR SYSTEM (BY PLUMBING CONTRACTOR) - SEE SHEET 30-P102 31 GAS SERVICE BY GAS UTILITY - VERIFY FINAL ROUTE AND 30 GAS METER LOCATION WITH GAS UTILITY. UTILITY MAY PREFER TO EXTEND SERVICE FROM EXISTING WOODLAND BOOSTER STATION TO PROPOSED STATION. 18 15 14 22 16 N 34TH AVE E 17 GENERAL NOTE: 1.4 ACTUAL OUTSIDE DIAMETER OF EXISTING WATER MAIN AND SANITARY MAIN MAY EXCEED CURRENT DIPRA STANDARDS. THE CONTRACTOR SHALL TEST PIT AND CONFIRM 21 COMPATIBILITY OF COUPLING FITTINGS TO BE USED 1.3 1.4 10 & 20 PROJECT NO. ENGINEERING | ARCHITECTURE | SURVEYING **WOODLAND BOOSTER STATION IMPROVEMENTS** FUNDING | PLANNING | ENVIRONMENTAL 332 W Superior Street, Duluth MN 55802 (218) 722-3915 www.msa-ps.com 00616177 DESIGNED BY DESIGNED BY: JL --- --CHECKED BY: SRC ----CITY OF DULUTH

CERTIFY THAT THIS PLAN, REPORT, OR SPECIFICATION WAS PREPARED BY ME OR UNDER MY DIRECT SUPERVISION OF AMOUNT LIGHT OF MINNESOTA.

LA RCLL

ST. LOUIS COUNTY, MINNESOTA

SHEET

05-C102

8202 Distribution: RK DCC AFC Entered on 8/9/2024 KEY NOTES # PHASE 2 TO BEGIN ONCE NEW BOOSTER STATION IS COMMISSIONED AND PROVEN RELIABLE. WRITTEN APPROVAL FROM ENGINEER REQUIRED PRIOR TO COMMENCMENT OF PHASE 2 WORK. 2 CAP & ABANDON IN PLACE EXISTING 20" DIP 2.1 SALVAGE PREVIOUSLY INSTALLED 20" MJ BUTTERFLY VALVE & VALVE BOX 9+33.96 2.2 PROVIDE 20" PLUG ON UNUSED BRANCH OF PREVIOUSLY INSTLALED 20" MJ TEE PROPOSED WOODLAND BOOSTER STATION 2.3 DISCONNECT & ABANDON IN PLACE EXISTING WATER SERVICE 3 CAP & ABANDON IN PLACE EXISTING 20" DIP 3.1 SALVAGE PREVIOUSLY INSTALLED 20" MJ BUTTERFLY VALVE & VALVE BOX 3.2 PROVIDE 20" PLUG ON UNUSED BRANCH OF PREVIOUSLY INSTLALED 20" MJ TEE 4 REMAINING CONCRETE FOUNDATION APPROXIMATELY 24" BELOW FINISHED GRADE E 4TH STREET 2.2 2.1 2.3 N 34TH AVE E 3.2 PROJECT NO. ENGINEERING | ARCHITECTURE | SURVEYING FUNDING | PLANNING | ENVIRONMENTAL 332 W Superior Street, Duluth MN 55802 (218) 722-3915 www.msa-ps.com **WOODLAND BOOSTER STATION IMPROVEMENTS** SITE-CIVIL 00616177 DESIGNED BY: DESIGNED BY: JL --- --
CHECKED BY: SRC ---- ---CITY OF DULUTH YARD PIPING PLAN - PHASE 2 SHEET ST. LOUIS COUNTY, MINNESOTA ENGINEER: Set Polit 05-C104

8202 Distribution: RK DCC AFC Entered on 8/9/2024 **ESTIMATED RESTORATION** CONSTRUCTION LIMITS, TYP. EROSION CONTROL BLANKETS, SEE NOTE #3 AREA OF WORK: 14,865 S.F. DRIVEWAY/SIDEWALK/PAVEMENT: 1,930 S.F. AREA TO BE RESTORED: 11,223 S.F. **GENERAL NOTES:** 1. CONTRACTOR SHALL CUT AND REMOVE STUMPS OF TREE FROM \bigcirc FRONT OF STRUCTURE. TREES HAVE BEEN REMOVED BY THE CITY OF DULUTH IN PRIOR WORK. STUMPS WERE NOT REMOVED BUT WILL NEED TO BE TO COMPLETE THIS PROJECT. 2. ALL DISTURBED AREAS, UNLESS OTHERWISE NOTED IN THE DRAWINGS OR SPECIFICATIONS, SHALL BE RESTORED WITH SEED PER MNDOT 3878. ALL SLOPES STEEPER THAN 4:1 (H:V) SHALL BE PROTECTED FROM STRE PROPOSED WOODLAND EROSION WITH EROSION CONTROL BLANKETS PER MNDOT 2575. **BITUMINOUS BOOSTER STATION** ALL ROLLED EROSION PRODUCTS SHALL BE CATEGORY 3N. DRIVEWAY CONTRACTOR MAY PROPOSE HYDRAULIC EROSION CONTROL PRODUCT AS AN ALTERNATE AT NO ADDITIONAL COST TO THE OWNER. CONTRACTOR SHALL INSPECT THE WORK AREA AND ADJACENT STREETS FOR SEDIMENT TRACKING. SEDIMENT TRACKED ONTO PAVED SURFACES SHALL BE SWEPT WITHIN 24 HOURS. INSTALL AND MAINTAIN BIOROLL SEED, FERTILIZE, & MULCH 34TH AVE E **INSTALL AND MAINTAIN** DISTURBED GROUND **INLET PROTECTION** PROJECT NO. ENGINEERING | ARCHITECTURE | SURVEYING FUNDING | PLANNING | ENVIRONMENTAL 332 W Superior Street, Duluth MN 55802 (218) 722-3915 www.msa-ps.com **WOODLAND BOOSTER STATION IMPROVEMENTS** SITE-CIVIL 00616177 DESIGNED BY DESIGNED BY: JL ---- ---CHECKED BY: SRC ---- ----CITY OF DULUTH **EROSION CONTROL PLAN** SHEET ST. LOUIS COUNTY, MINNESOTA CERTIFY THAT THIS PLAN, REPORT, OR SPECIFICATION WAS PREPARED BY ME OR UNDER MY DIRECT SUPERVISION OF AMOUNT LICENSED PROFESSIONAL ENGINEER UNDER THE LAWS OF THE STATE OF MINNESOTA. Sor P Chile 05-C107