

## Planning & Development Division

Planning & Economic Development Department



Room 160 411 West First Street Duluth, Minnesota 55802

File Number	PL 23-076	5	Contact Jenn Mose		S		
Туре	MU-I Plar	nning Review	Planning Commission Date				May 9, 2023
Deadline	Applicat	ion Date	April 5, 2023 <b>60 Days</b>				June 4, 2023
for Action	Date Ext	ension Letter Mailed	April 27, 2023		120 Days		August 3, 2023
Location of Sub	ject	1002 E 1st Street					
Applicant	St. Luke'	s Hospital	Contact	Michae	ael Boeselager		
Agent	ent Erdman Company		Contact	Neil Bri	Neil Bright		
Legal Description		N/A	Sign Notice	gn Notice Date		April 21, 2023	
Site Visit Date		April 27, 2023	Number of Letters S		Sent	11	

#### **Proposal**

Applicant is proposing a 3-level, 323-stall parking ramp to replace the existing parking ramp. The height of the proposed building is 43'-10" from the average grade surrounding the structure to the top of the highest roof point.

#### Staff Recommendation

Staff is recommending Planning Commission approve the Planning Review subject to conditions.

	Current Zoning	Existing Land Use	Future Land Use Map Designation
Subject	MU-I	Medical	Medical District
North	MU-I	Medical (Parking)	Medical District
South	MU-I	Medical	Medical District
East	MU-I	Medical (Parking)	Medical District
West	MU-I	Medical	Medical District

## **Summary of Code Requirements**

- 50-15.4 MU-I Planning Review
- 50-23 Connectivity and Circulation Focuses on pedestrian and bicycle accommodations.
- 50-24 Parking and Loading Addresses required parking spaces, loading docks, and snow storage.
- 50-25 Landscaping and Tree Preservation Landscaping requirements and tree preservation
- 50-26 Screening, Walls, & Fences Includes requirements for screening of commercial containers & mechanical equipment
- 50-29 Sustainability Standards Sustainability point system for new development.
- 50-30 Design Standards Building standards for multi-family, commercial, institutional, and industrial buildings.
- 50-31 Exterior Lighting Requires lighting to be downcast, full-cutoff fixtures.
- 50-37.11 Planning Review Planning Commission shall approve the Planning Review or approve it with modifications, if it is determined that the application complies with all applicable provisions of this Chapter.

Comprehensive Plan Governing Principle and/or Policies and Current History (if applicable):

**Governing Principle #4-Support economic growth sectors:** Emerging and growing economic sectors, including medical, add economic, cultural, and social diversity.

**Economic Development Policy #2**—Foster growth of existing employers and strategically recruit new employers to Duluth.

Future Land Use – Medical District: An area encompassing the medical campuses and adjacent that support them.

#### **Recent History**

The existing parking ramp was built in the late 1970s and had a capacity of 263 spaces. Due to deterioration of the slab, the 3<sup>rd</sup> floor has been closed to use, leaving 170 usable parking spaces.

In January 2013, Planning Commission approved a District Plan for St. Luke's (PL 12-170), establishing guidelines for signage, traffic calming, and lighting.

## Discussion

Staff finds that:

- 1) Applicant proposes a 3-level, 323-stall parking ramp to replace the existing parking spaces. This will provide an additional 60 spaces, or 20% capacity over the existing ramp.
- 2) There is a development agreement, separately approved, between the City and St. Luke's related to the ramp. The City, in conjunction with the state of Minnesota, is providing funding to support construction of this ramp.
- 3) Design of the structure, including structural columns and size of the elevator and stairs, will support an additional 3 levels if needed in the future. A potential space for a future second elevator is accommodated on the east end, and space for a future snow chute when the structure is expanded.
- 4) St. Luke's, as a regional medical system, takes a campus-wide approach to accommodating parking needs. The hospital has identified a shortage of staff parking, which will be alleviated with this ramp.
- 5) Continued use of off-street parking in a parking structure, in comparison to surface level off-street parking spaces, provides stronger access to the St. Luke's campus and reduces negative externalities to the neighborhood. Should the new ramp provide the opportunity to reduce or eliminate off-street surface parking, such an action would be consistent with the directives of adopted planning documents.
- 6) As this location already has an existing parking ramp, traffic levels and flow are not expected to change. The new ramp adds an additional entry/exit lane as well as more queuing space over what is available today. No traffic study is needed for this project.
- 7) Applicant plans minimal signage for the parking ramp; signage will meet requirements in the approved MU-I District Plan (PL 12-170). Signage will be strategically placed to direct people to the Lakeview building, Northland building, and St. Luke's campus, as well as to identify the ramp for users. All signage will need to also meet UDC requirements and receive sign permits prior to installation.
- 8) Landscaping and Tree Preservation: Proposal shows trees and shrubs that meet the street frontage requirements of UDC Section 50-25.
- 9) Screening, Walls, and Fences: Does not apply.
- 10) Sustainability Standards: Ramp will include LED lighting, a drainage separation system to remove oil and gas contamination, and a majority of materials that are reuseable if and when the ramp is demolished. Spaces will be programmed for compact parking where appropriate, and conduit will allow for EV charging in the future. Final sustainability points will need to be identified at the time of building permit application.
- 11) Building Design Standards: The design includes precast spandrel walls to cover the headlights and fronts of cars parked along the street and alley facing facades. Stamped precast gives the impression of brick and creates façade breaks to add interest. A large signage wall, stairs at both ends, and a glass curtain wall at the east stair all add interest. Building design will need to meet requirements in Section 50-30.5 and will be verified at the time of building permit.
- 12) Exterior Lighting: All lighting will be 3000K or less with full cut-off fixtures and will meet all requirements in Section 50-31.
- 13) No public, agency, or City comments have been received.
- 14) According to UDC 50-37.1.N, an approved Planning Review will expire if the project or activity authorized by the permit is not begun within 1 year.


#### **Staff Recommendation**

Based on the above findings, Staff recommends that Planning Commission approve the MU-I Planning Review with the following conditions:

- 1. The project be constructed, limited to, and maintained according floor plans, exterior elevations, landscape plan, and lighting details submitted with the application.
- 2. Any alterations to the approved plans that do not alter major elements of the plan may be approved by the Land Use Supervisor without further Planning Commission approval; however, no such administrative approval shall constitute a variance from the provisions of Chapter 50.





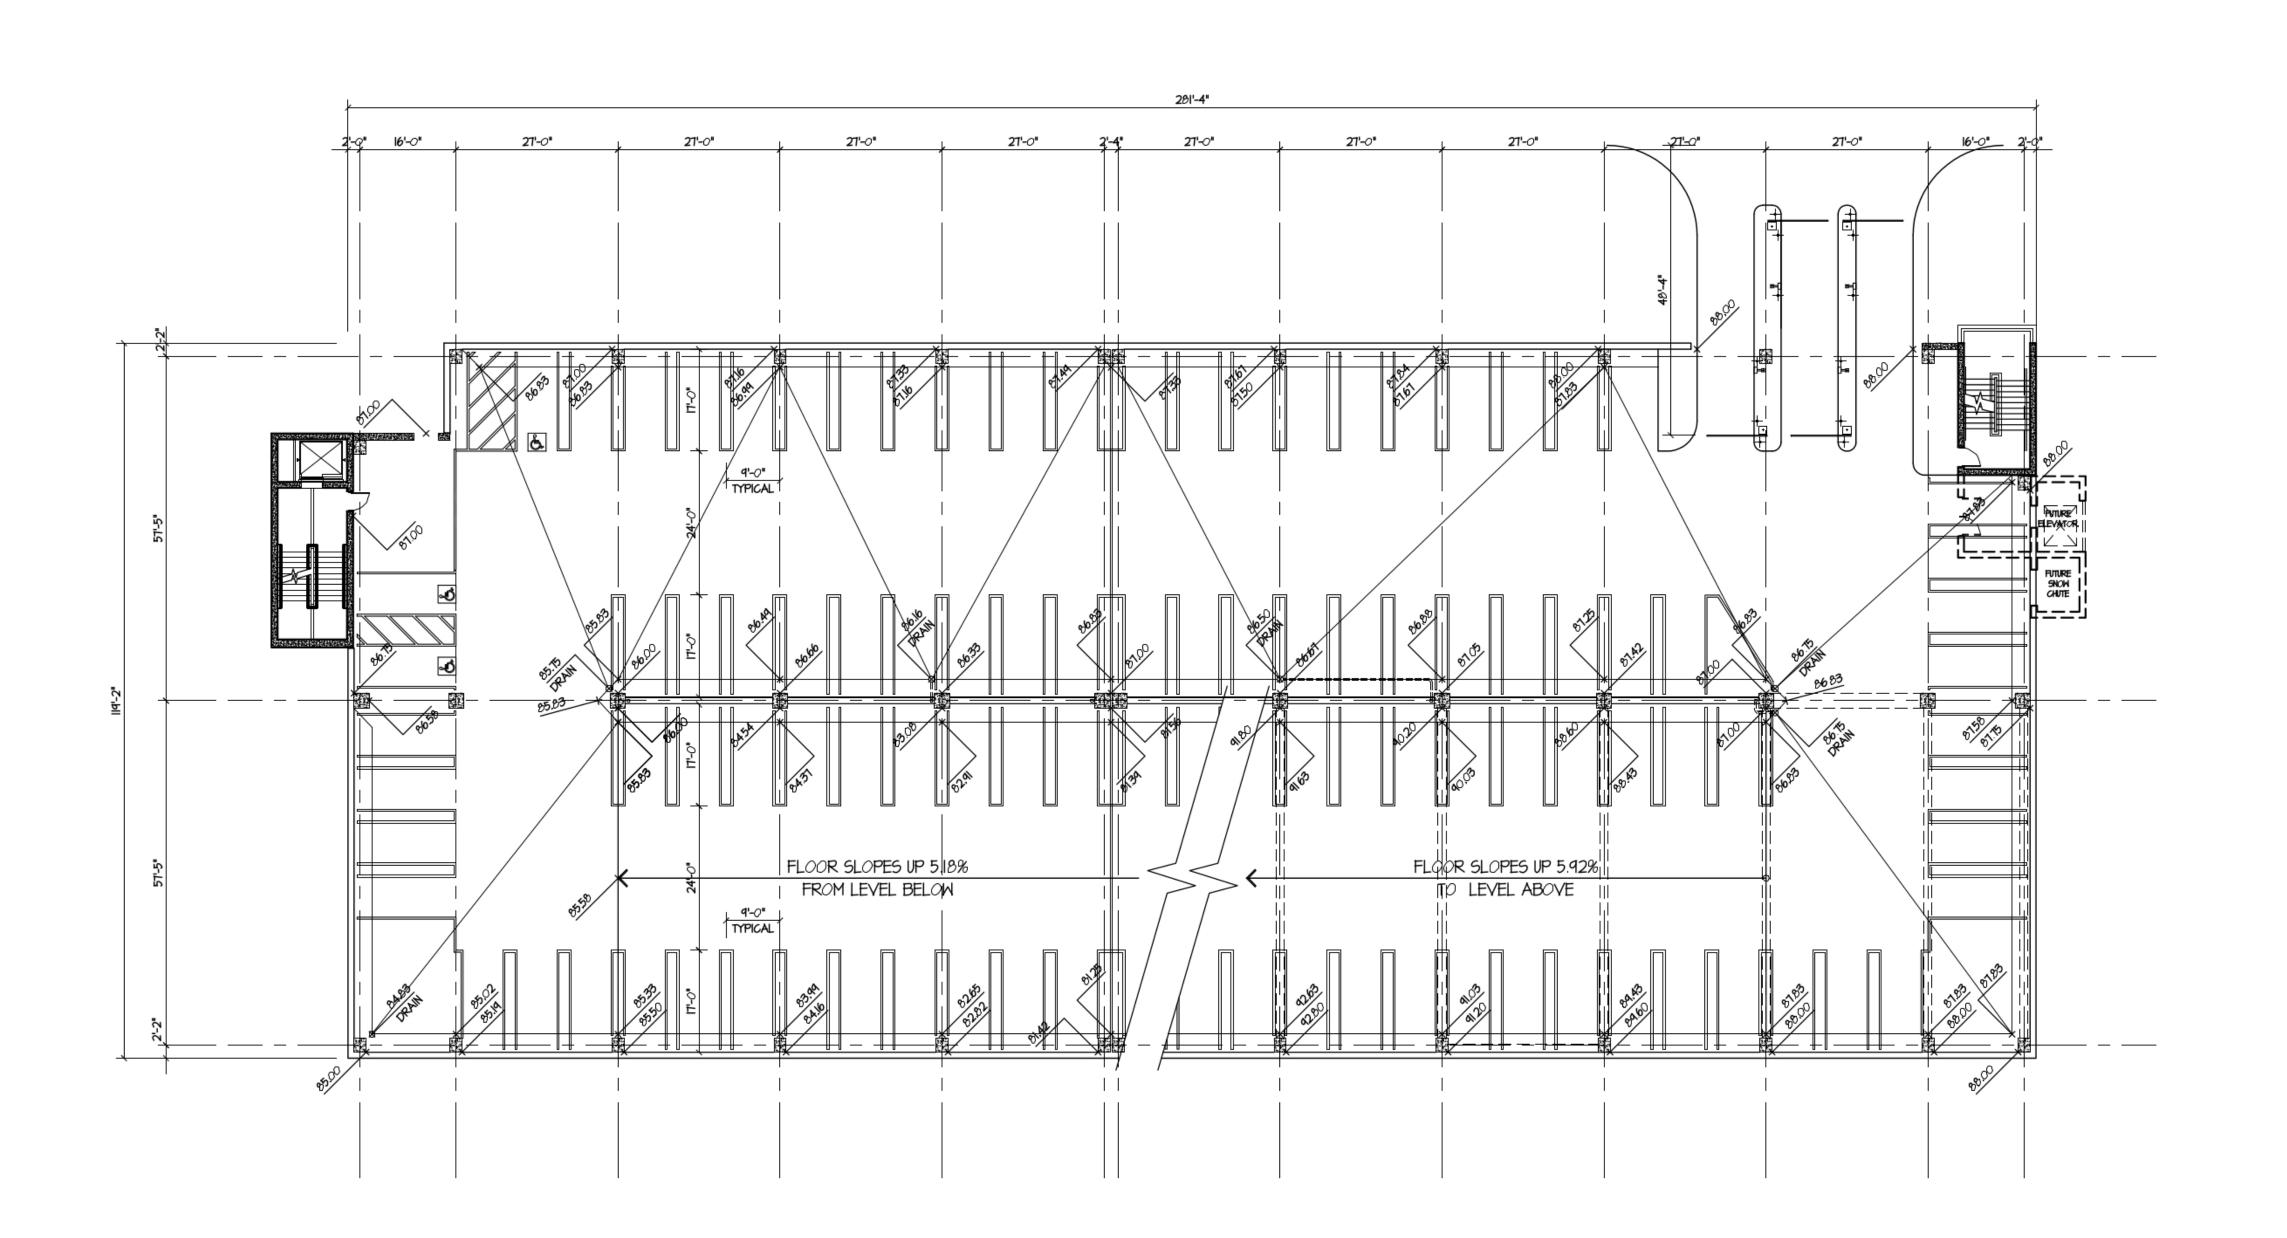

**GROUND** LEVEL

CAR COUNT SUMMARY									
LEVEL STANDARD BARRIER FREE TOTAL/LEVE									
LOWER LEVEL	29	0	29						
GROUND LEVEL	100	3	103						
SECOND LEVEL	106	3	109						
THIRD LEVEL	80	2	82						
TOTALS	315	8	323						

ERDMAN

One Erdman Place P.O. Box 44975 Madison, Wisconsin 53717 Phone: (608) 410-8000 FAX: (608) 410-8500



1000 E. 1ST Street Duluth, MN. 53805

Architectural Services Provided By: **ERDMAN COMPANY** 

Replacement

Engineering Services Provided By:
ERDMAN COMPANY
MEYER/BORGMAN/JOHNSON
SEH, INC.

Contractor Services Provided By:


ERDMAN COMPANY

Lic. No. IR652277

Consultant Services Provided By: RICH & ASSOCIATES INC.


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Sheet Name

Drn: Chk:
Sheet Number

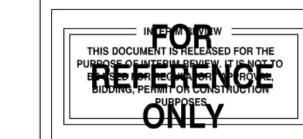

SECOND LEVEL



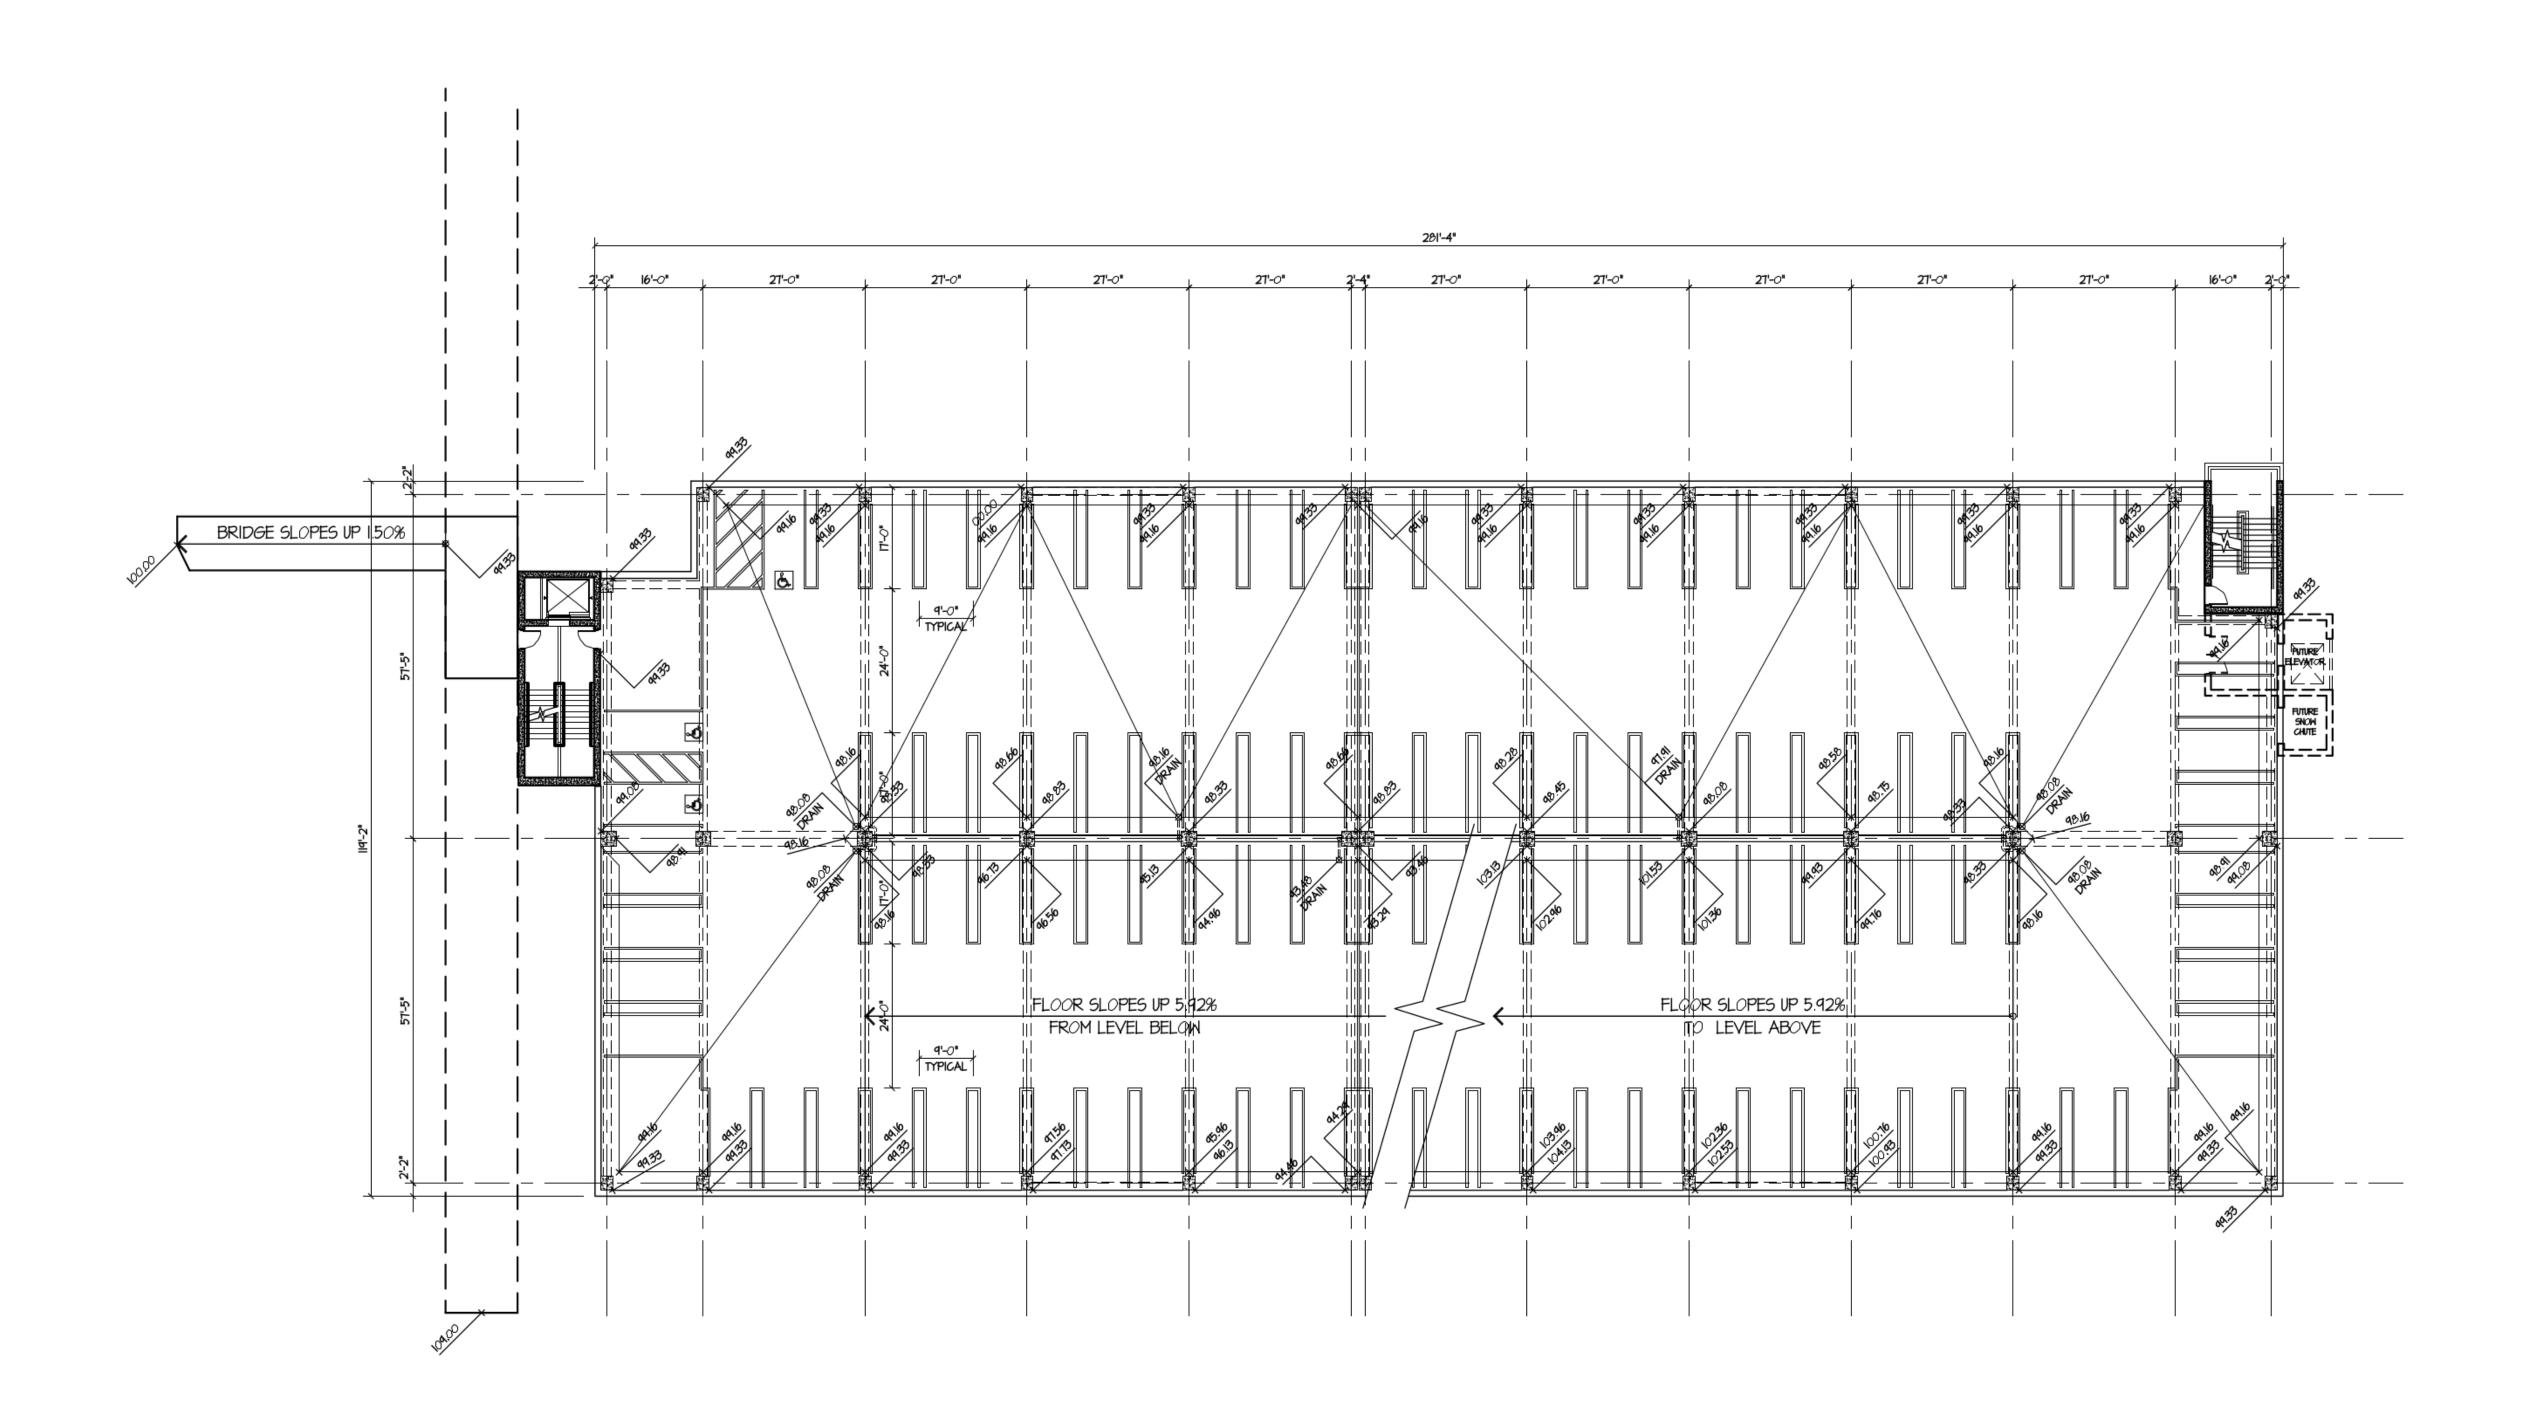

Replacement

1000 E. 1ST Street
Duluth, MN. 53805

Architectural Services Provided By: ERDMAN COMPANY


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ERDMAN COMPANY
MEYER/BORGMAN/JOHNSON
SEH, INC.

Contractor Services Provided By:
ERDMAN COMPANY
Lic. No. IR652277

Consultant Services Provided By: RICH & ASSOCIATES INC.

No. Description Date


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A102

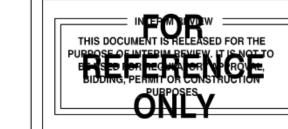

THIRD (ROOF) LEVEL



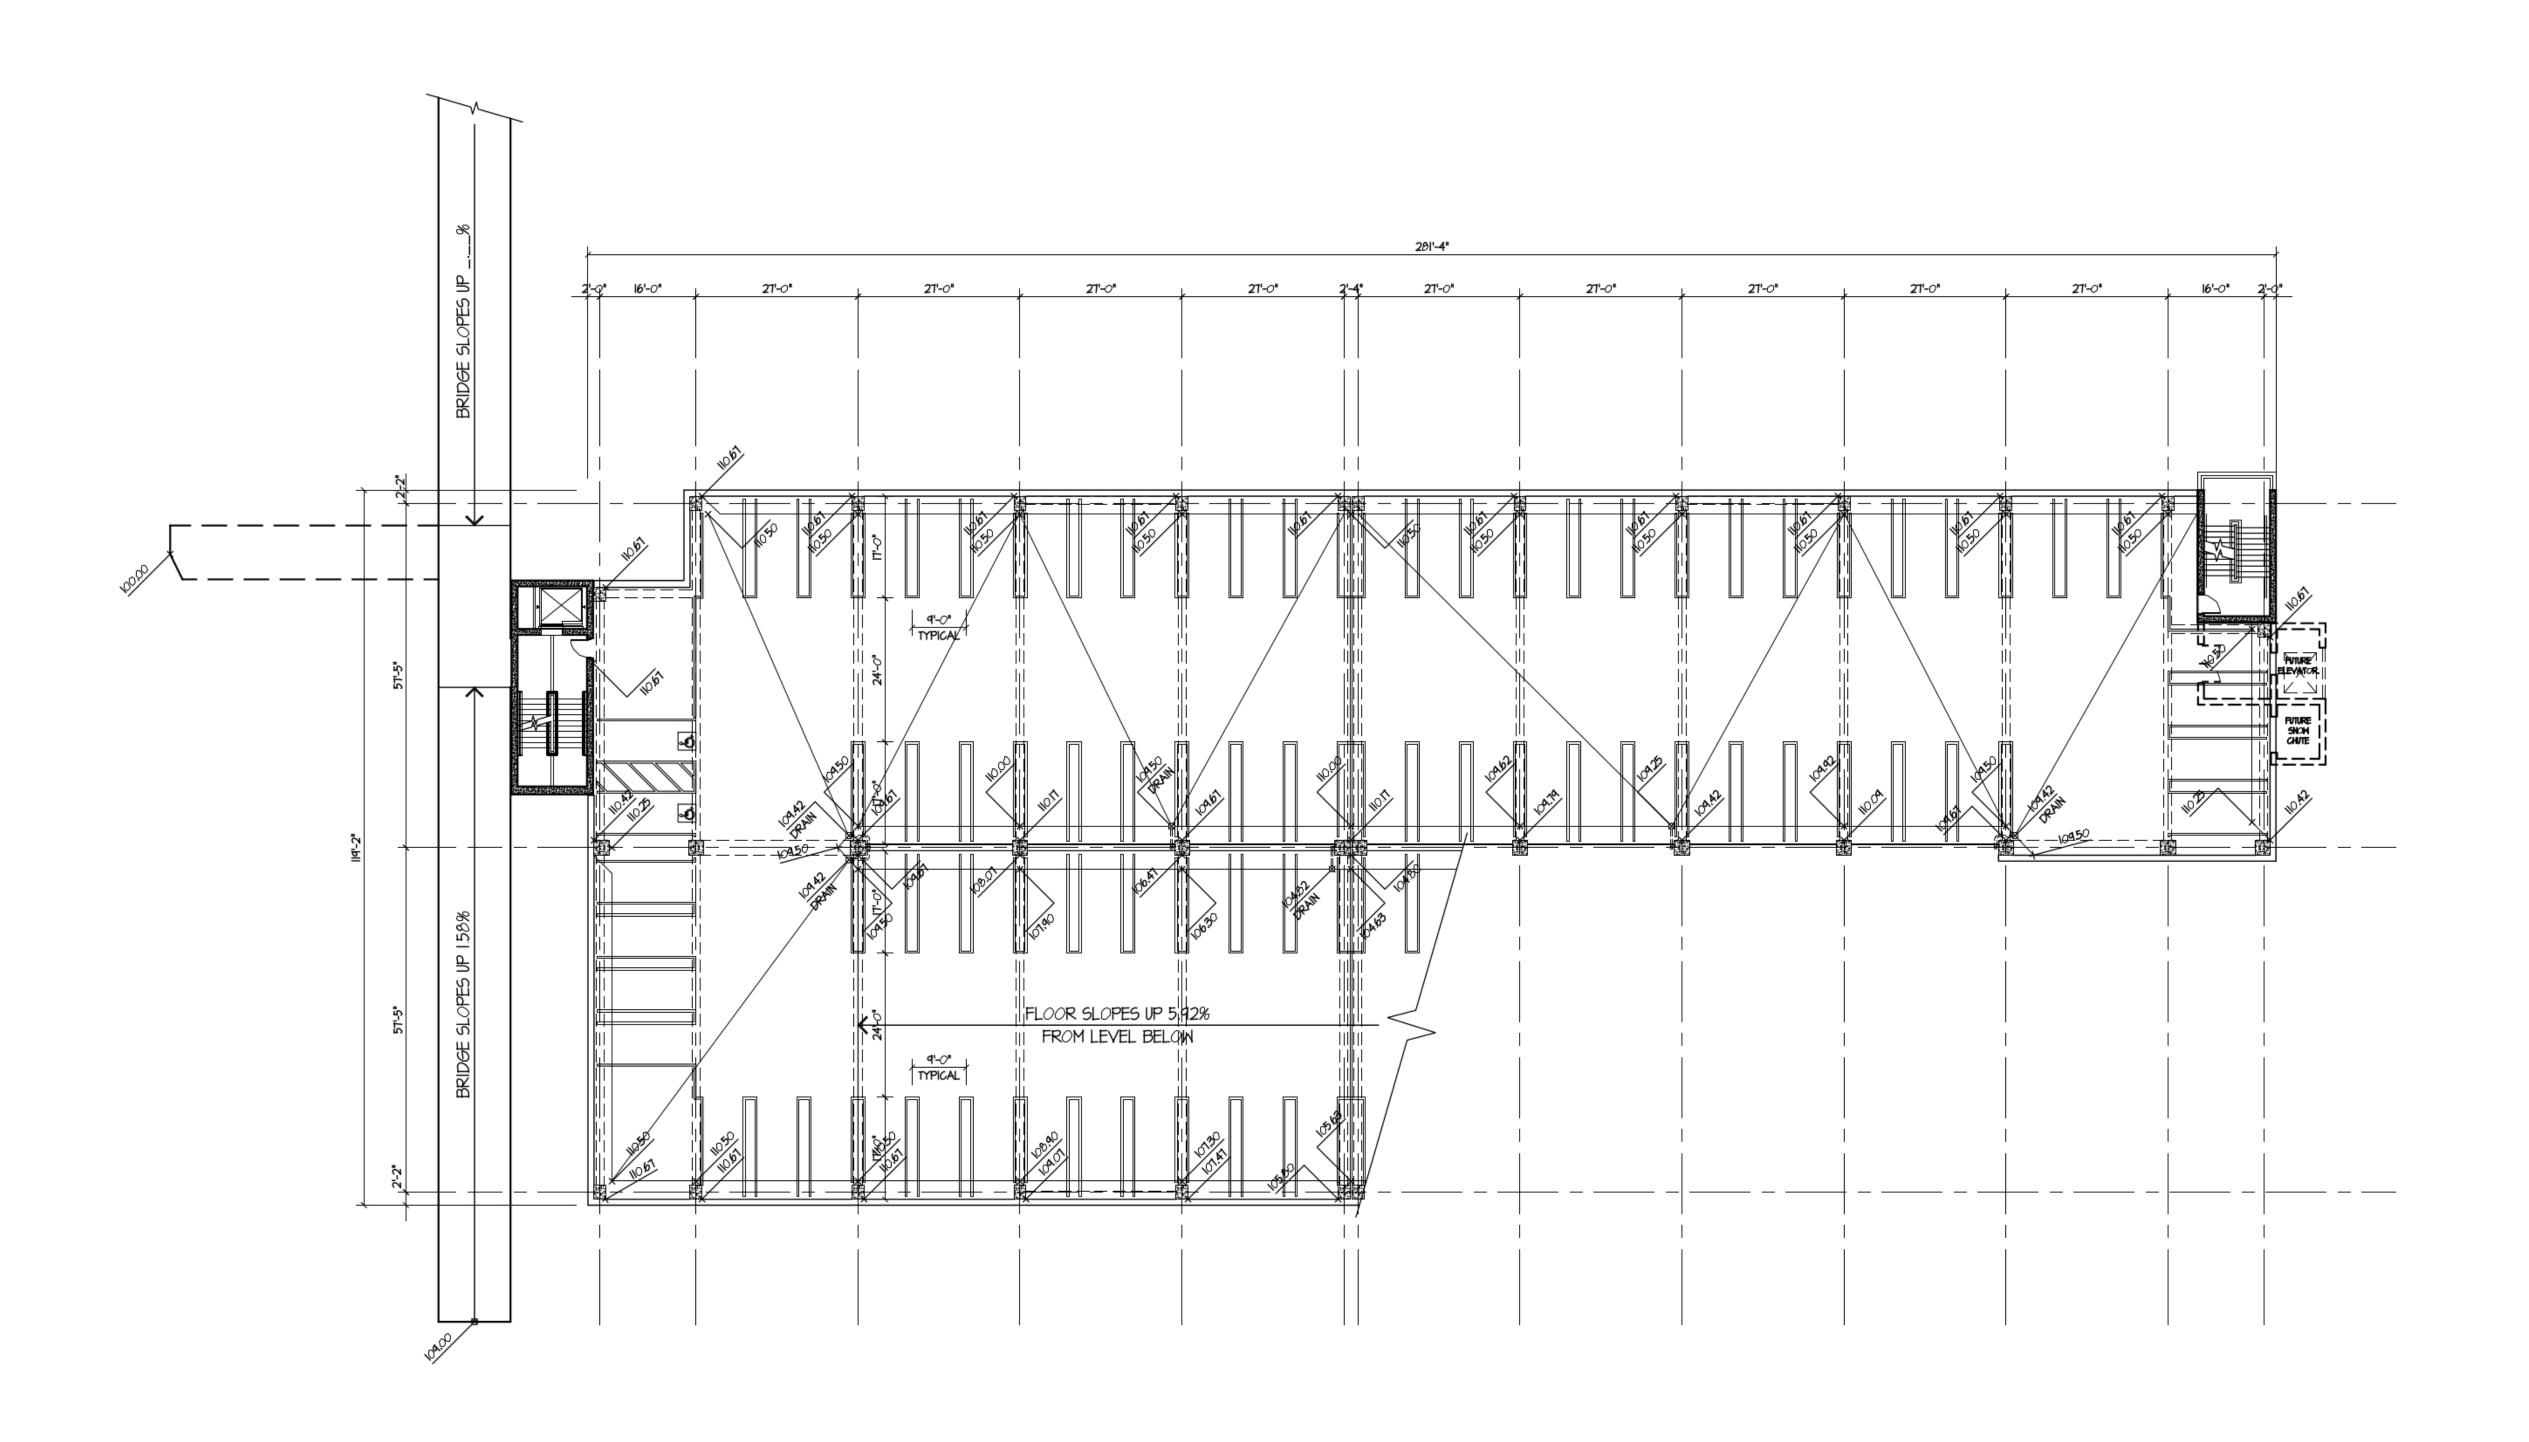

Replacement

1000 E. 1ST Street
Duluth, MN. 53805

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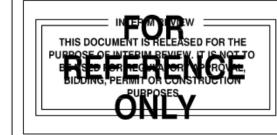
Engineering Services Provided By:
ERDMAN COMPANY
MEYER/BORGMAN/JOHNSON
SEH, INC.

Contractor Services Provided By:
ERDMAN COMPANY
Lic. No. IR652277

Consultant Services Provided By: RICH & ASSOCIATES INC.

No. Description Date

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Sheet Name

Sheet Number

A103



Parking Ramp Replacement


1000 E. 1ST Street Duluth, MN. 53805


Architectural Services Provided By: **ERDMAN COMPANY** 

Engineering Services Provided By: ERDMAN COMPANY MEYER/BORGMAN/JOHNSON SEH, INC.

Contractor Services Provided By: ERDMAN COMPANY Lic. No. IR652277

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Sheet Name

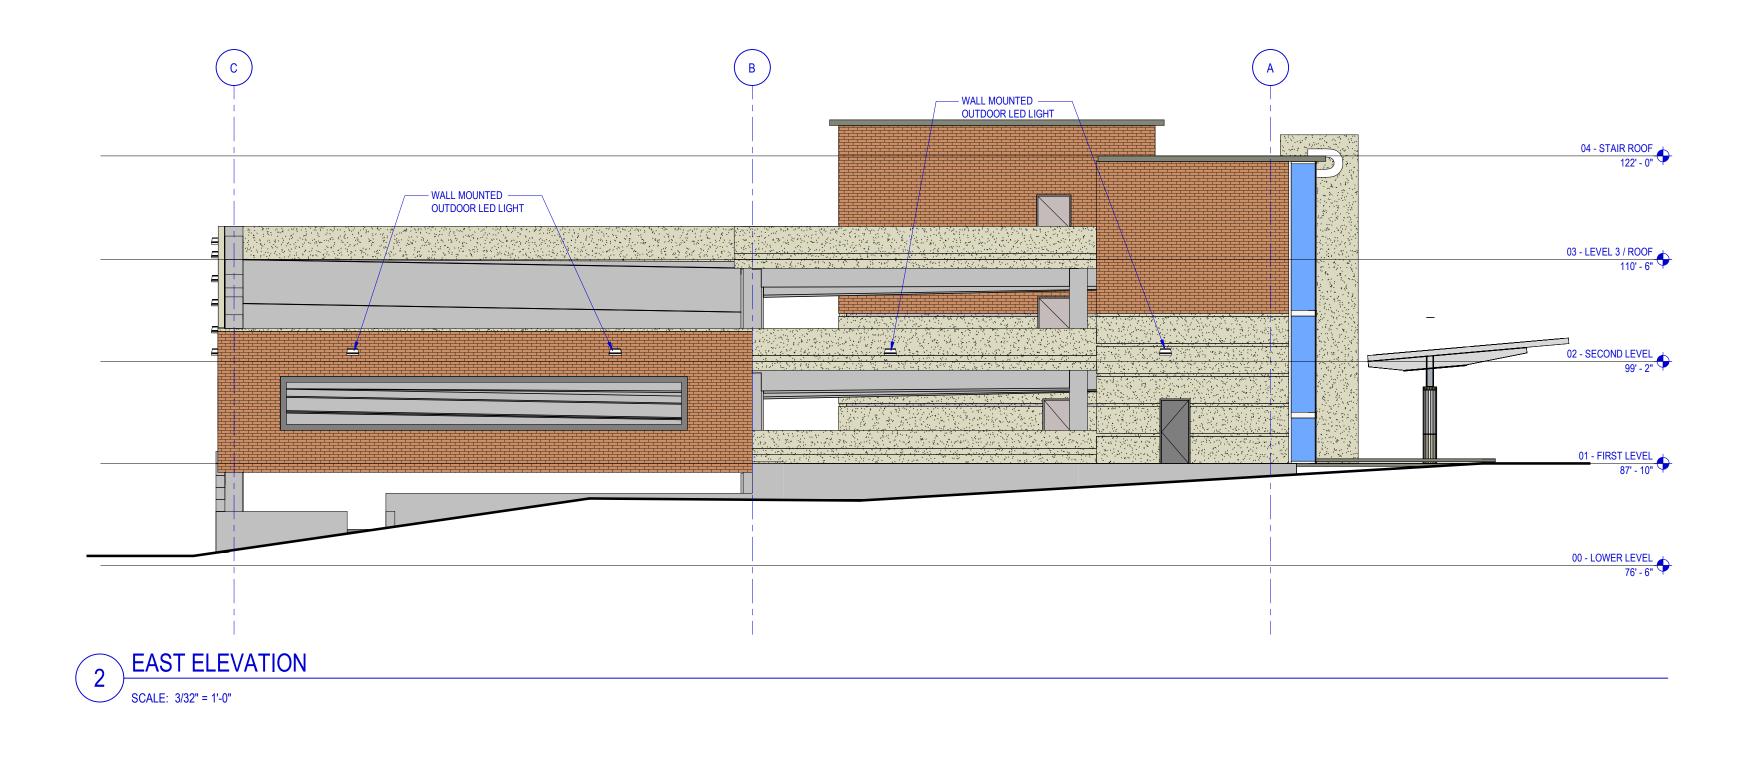**EXTERIOR ELEVATIONS** 

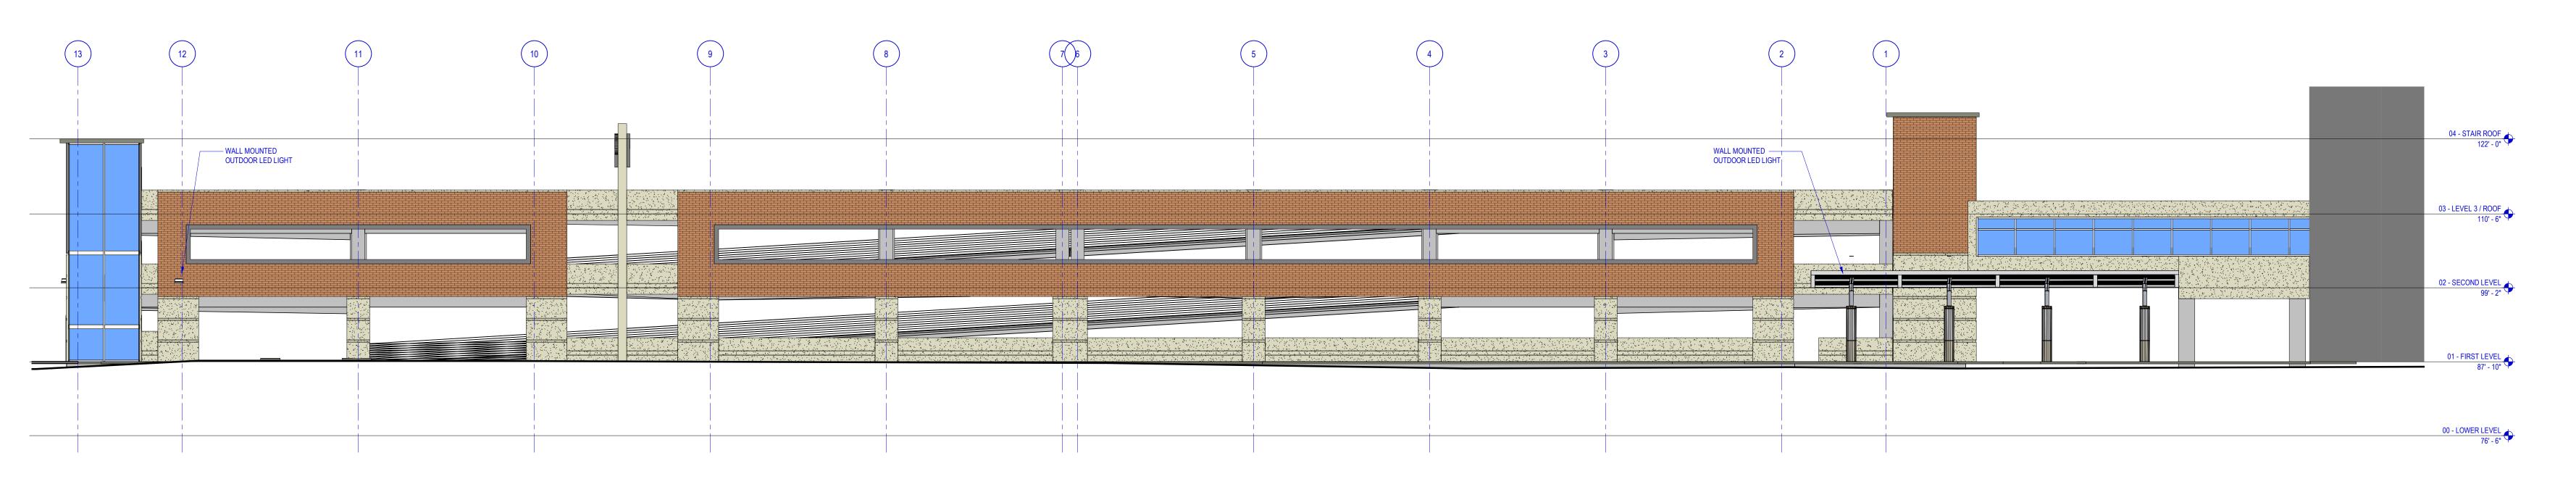Drn:ERDMAN Chk:ERDMAN

JOB #667220

NORTH ELEVATION

SCALE: 3/32" = 1'-0"

Parking Ramp Replacement


1000 E. 1ST Street Duluth, MN. 53805


Architectural Services Provided By: **ERDMAN COMPANY** 

Engineering Services Provided By: ERDMAN COMPANY MEYER/BORGMAN/JOHNSON SEH, INC.

Contractor Services Provided By: ERDMAN COMPANY Lic. No. IR652277

Consultant Services Provided By:

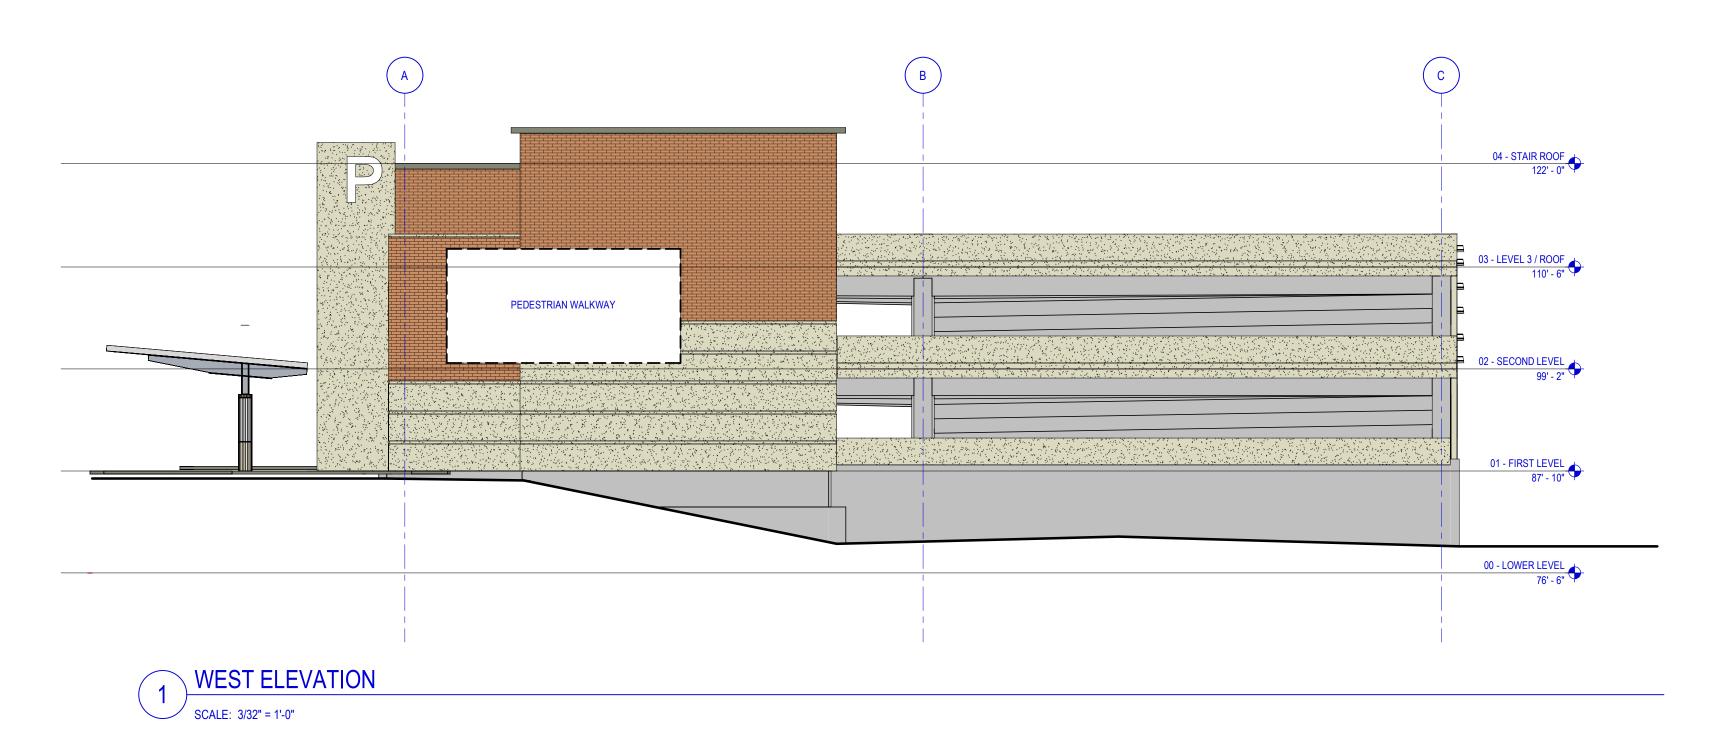

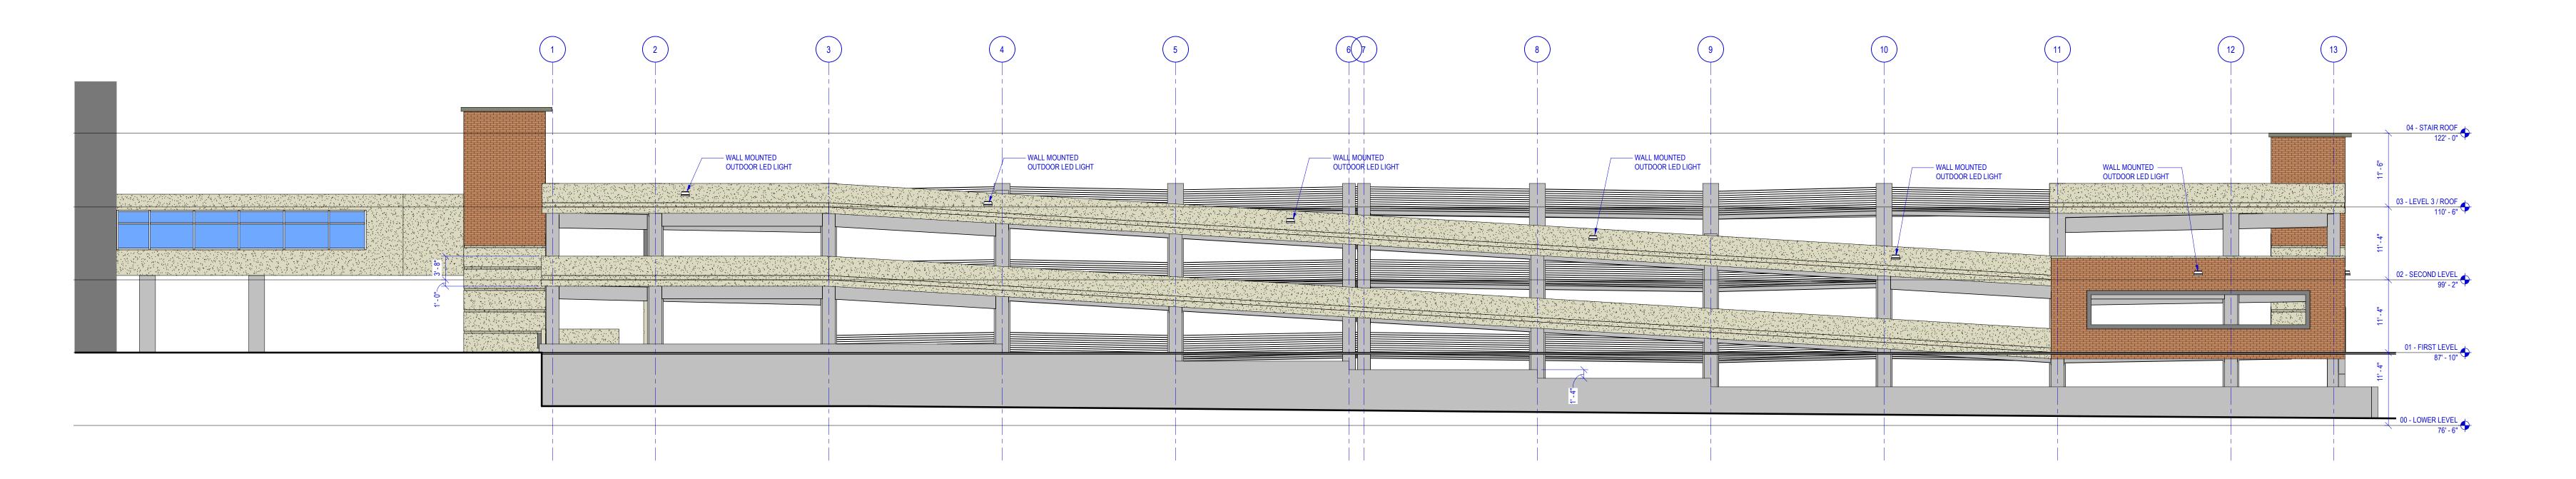

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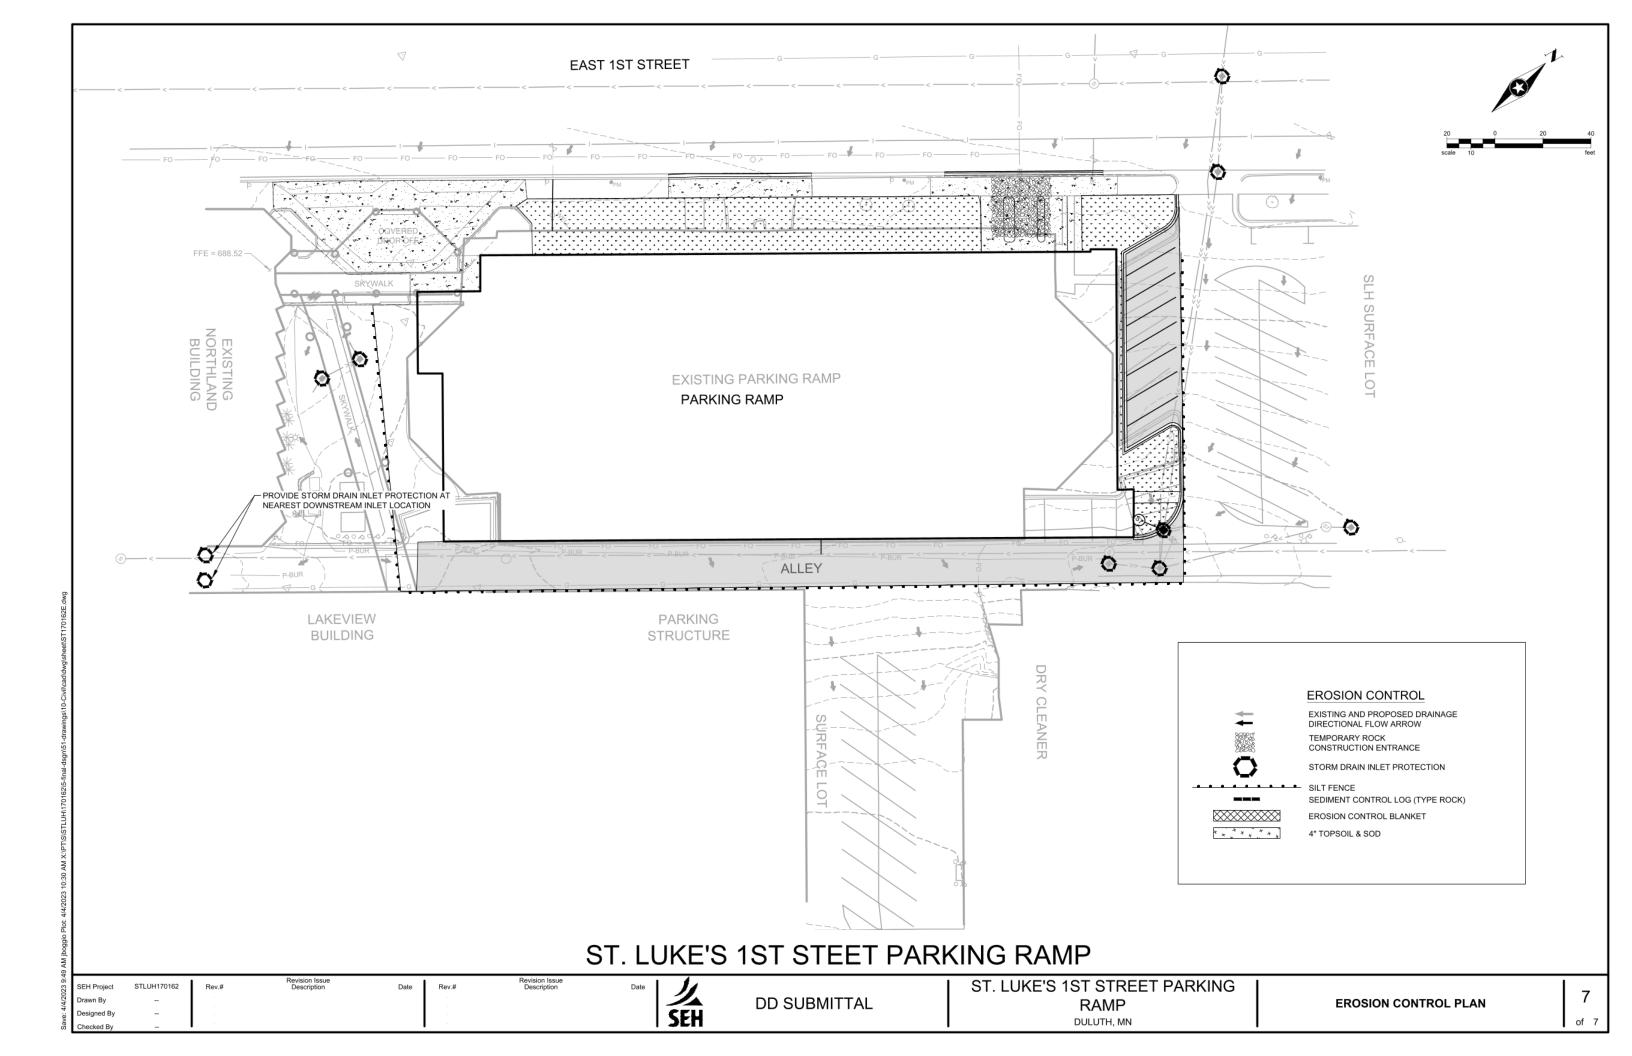
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Sheet Name **EXTERIOR** 

**ELEVATIONS** 

Drn:Author

JOB #667220













3.75"

### **Specifications**


Diameter: 19"

**Height:** 3.75"

(4.85" with Up-Light)

18 lbs

Weight (max, with no options):

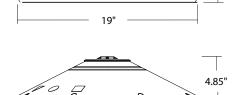


19'



#### Introduction

The all new VCPG LED (Visually Comfortable Parking Garage) luminaire is designed to bring glare control, optical performance and energy savings into one package. The recessed lens design of VCPG LED minimizes high angle glare, while its precision molded acrylic lens eliminates LED pixilation and delivers the required minimums, verticals and uniformity. The dedicated up-light module option reduces the contrast between the luminaire and the ceiling creating a more visually comfortable environment.

The VCPG LED delivers up to 87% in energy savings when replacing 175W metal halide luminaires. With over 100,000 hour life expectancy (12+ years of 24/7 continuous operation), the VCPG LED luminaire provides significant maintenance savings over traditional luminaires.

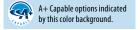

## **Ordering Information**

#### **EXAMPLE: VCPG LED V4 P4 40K 70CRI T5M MVOLT SRM DNAXD**

VCPG LED							
Series	LED Light Engines	Package	Color temperature	Color Rendering Index	Distribution	Voltage	Mounting
VCPG LED	V4 <sup>1</sup> 4Light Engines V8 <sup>1</sup> 8 Light Engines	P1 <sup>1</sup> P2 <sup>1</sup> P3 <sup>1</sup> P4 <sup>1</sup> P5 <sup>1</sup> P6 <sup>1</sup> P7 <sup>1</sup>	30K 3000 K 35K 3500 K 40K 4000 K 50K 5000 K	70CRI 80CRI	T5M Type V, medium T5R <sup>2</sup> Type V, rectangular T5E Type V entry LANE <sup>2</sup> Drive lane	MVOLT For ordering 347 120 480 208 240 277 347 480	Shipped included PM Pendant mount standard (24-inch length supply leads) SRM Surface mount (24-inch length supply leads) Shipped separately YK Yoke/trunnion mount <sup>9</sup>

Options				Finish (red	quired)
Shipped in UPL1 UPL2 E8WC E10WH HA SF DF SPD10KV LDS36 LDS72 LDS108 DMG Shipped Se WG BDS HS	Up-Light: 500 lumens Up-Light: 700 lumens Emergency battery backup, CEC compliant (8W, -20°C min) <sup>3,4,5</sup> Emergency battery backup, CEC compliant (10W, 5°C min) <sup>3,4,5</sup> High ambient (50°C, only P1-P4) Single fuse (120V, 277V, 347V) Double fuse (208V, 240V, 480V) 10KV Surge Pack 36in (3ft) lead length 72in (6ft) lead length 108in (9ft) lead length External 0-10V leads (no controls) <sup>6</sup>	Standalone Sen PIR PIRH PIR3FC3V PIRH3FC3V924 PIRH3FC3V924  Networked Sen NLTAIR2 PIR NLTAIR2 PIRH XAD XAD924 XAD PIR XAD PIRH XAD PIRH XAD PIRH XAD924 PIR	Motion/ambient sensor for 8-15' mounting heights  Motion/ambient sensor for 15-30' mounting heights  Motion/ambient sensor for 8-15' mounting heights, pre programmed to 3fc and 35% light output  Motion/ambient sensor for 15-30' mounting heights, pre programmed to 3fc and 35% light output  UL924 Listed motion/ambient sensor for emergency circuit for 8-15' mounting heights, pre programmed to 3fc and 35% light output  UL924 Listed motion/ambient sensor for emergency circuit for 15-30' mounting heights, pre programmed to 3fc and 35% light output <sup>10</sup>	DWHXD DNAXD DDBXD DBLXD	White  Natural aluminum  Dark bronze  Black





# WDGE2 LED

Architectural Wall Sconce Precision Refractive Optic











## **Specifications**


 Depth (D1):
 7"


 Depth (D2):
 1.5"

 Height:
 9"

 Width:
 11.5"

 Weight:
 (without options)

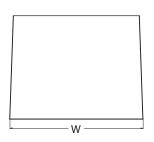

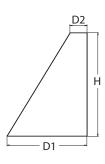

#### Introduction

The WDGE LED family is designed to meet specifier's every wall-mounted lighting need in a widely accepted shape that blends with any architecture. The clean rectilinear design comes in four sizes with lumen packages ranging from 1,200 to 25,000 lumens, providing a true site-wide solution. Embedded with nLight® AIR wireless controls, the WDGE family provides additional energy savings and code compliance.

WDGE2 with industry leading precision refractive optics provides great uniform distribution and optical control. When combined with multiple integrated emergency battery backup options, including an 18W cold temperature option, the WDGE2 becomes the ideal wall-mounted lighting solution for pedestrian scale applications in any environment.

# **WDGE LED Family Overview**

Luminaire	Outies	Standard EM, 0°C	Cold EM, -20°C	Sensor -	Approximate Lumens (4000K, 80CRI)						
	Optics				P0	P1	P2	Р3	P4	P5	P6
WDGE1 LED	Visual Comfort	4W			750	1,200	2,000				
WDGE2 LED	Visual Comfort	10W	18W	Standalone / nLight	-	1,200	2,000	3,000	4,500	6,000	
WDGE2 LED	Precision Refractive	10W	18W	Standalone / nLight	700	1,200	2,000	3,200	4,200		
WDGE3 LED	Precision Refractive	15W	18W	Standalone / nLight		7,500	8,500	10,000	12,000		
WDGE4 LED	Precision Refractive			Standalone / nLight	-	12,000	16,000	18,000	20,000	22,000	25,000

#### **Ordering Information**

#### **EXAMPLE: WDGE2 LED P3 40K 80CRI VF MVOLT SRM DDBXD**

Series	Package	Color Temperature	CRI	Distribution	Voltage	Mounting			
WDGE2 LED	P0 <sup>1</sup> P1 <sup>2</sup> P2 <sup>2</sup> P3 <sup>2</sup> P4 <sup>2</sup>	27K 2700K 30K 3000K 40K 4000K 50K 5000K AMB <sup>3</sup> Amber	70CRI <sup>4</sup> 80CRI LW <sup>3</sup> Limited Wavelength	T1S Type I Short T2M Type II Medium T3M Type III Medium T4M Type IV Medium TFTM Forward Throw Medium	MVOLT 347 <sup>5</sup> 480 <sup>5</sup>	Shipped included SRM Surface mounting bracket ICW Indirect Canopy/Ceiling Washer bracket (dry/ damp locations only)6	Shipped separately  AWS 3/8inch Architectural wall spacer  PBBW Surface-mounted back box (top, left, right conduit entry). Use when there is no junction box available.		

Options				Finish	
E10WH E20WC PE <sup>7</sup> DMG <sup>8</sup> BCE	Emergency battery backup, Certified in CA Title 20 MAEDBS (10W, 5°C min)  Emergency battery backup, Certified in CA Title 20 MAEDBS (18W, -20°C min)  Photocell, Button Type 0-10V dimming wires pulled outside fixture (for use with an external control, ordered separately)  Bottom conduit entry for back box (PBBW). Total of 4 entry points.	Standalone So PIR PIRH PIR1FC3V PIRH1FC3V	Bi-level (100/35%) motion sensor for 8-15' mounting heights. Intended for use on switched circuits with external dusk to dawn switching.  Bi-level (100/35%) motion sensor for 15-30' mounting heights. Intended for use on switched circuits with external dusk to dawn switching  Bi-level (100/35%) motion sensor for 8-15' mounting heights with photocell preprogrammed for dusk to dawn operation.  Bi-level (100/35%) motion sensor for 15-30' mounting heights with photocell preprogrammed for dusk to dawn operation.	DDBXD DBLXD DNAXD DWHXD DSSXD DDBTXD DBLBXD DNATXD	Dark bronze Black Natural aluminum White Sandstone Textured dark bronze Textured black Textured natural aluminum
BAA	Buy America(n) Act Compliant	Networked Se	ensors/Controls  nLightAIR Wireless enabled bi-level motion/ambient sensor for 8-15' mounting heights.	DWHGXD DSSTXD	Textured white Textured sandstone
		NLTAIR2 PIRH See page 4 for out	nLightAIR Wireless enabled bi-level motion/ambient sensor for 15-30' mounting heights.	5351ND	restared June 1011



COMMERCIAL OUTDOOR

