

Planning & Development Division

Planning & Economic Development Department



Room 160 411 West First Street Duluth, Minnesota 55802

File Number	PL 24-006		Contact		Jenn Moses		
Туре	MU-I Planning Review		Planning Commission Date			February 13, 2024	
Deadline for Action	Application Date		January 11, 2024		60 Days		March 11, 2024
	Date Extension Letter Mailed		January 24, 2024		120 Days		May 10, 2024
Location of Subject 1012 E 2 nd St		1012 E 2 nd St					
Applicant	St. Luke's Hospital		Contact	Michae	Michael Boeselager		
Agent	Erdman Company		Contact	Neil Br	Neil Bright		
Legal Description		010-3830-04940	Sign Notice Date		January 30, 2024		
Site Visit Date		February 2, 2024	Number of Letters Sent		17		

Proposal

Applicant is proposing to remove the existing helipad on top of the Building A parking garage, and relocate it to the top of Building A.

Staff Recommendation

Staff is recommending Planning Commission approve the Planning Review subject to conditions.

	Current Zoning	Existing Land Use	Future Land Use Map Designation
Subject	MU-I	Hospital campus	Institutional
North	MU-I	Hospital campus	Institutional
South	MU-I	Hospital campus	Institutional
East	MU-I	Hospital campus	Institutional
West	MU-I	Hospital campus	Institutional

Summary of Code Requirements

- 50-15.4 MU-I Planning Review
- 50-23 Connectivity and Circulation Focuses on pedestrian and bicycle accommodations. Includes design requirements for skywalks.
- 50-24 Parking and Loading Addresses required parking spaces, loading docks, and snow storage.
- 50-25 Landscaping and Tree Preservation Landscaping requirements and tree preservation
- 50-26 Screening, Walls, & Fences Includes requirements for commercial containers & mechanical equipment
- 50-29 Sustainability Standards Sustainability point system for new development.
- 50-30 Design Standards Building standards for multi-family, commercial, institutional, and industrial buildings.
- 50-31 Exterior Lighting Requires lighting to be downcast, full-cutoff fixtures.
- 50-37.11 Planning Review Planning Commission shall approve the Planning Review or approve it with modifications, if it is determined that the application complies with all applicable provisions of this Chapter.

Comprehensive Plan Governing Principle and/or Policies and Current History (if applicable):

Governing Principle #4 – Support economic growth sectors. This includes the medical sector. St. Luke's uses the heliport for crucial patient transport.

Future Land Use – Institutional. Applicable to medical, university/college, public school, religious, or governmental campuses.

History:

- FN 11-011, MU-I Planning Review for 1st Phase of Building A
- PL 18-158, MU-I Planning Review for St. Luke's Hospital that included establishment of the helipad in its current location on top of the parking garage for Building A
- PL 22-212, MU-I Planning Review for a vertical expansion of Building A

Discussion

Staff finds that:

- 1) The existing helipad on the top of the Building A parking garage was approved in 2018; at that time, detailed analyses of the noise and wind resulting from the helipad were conducted, as the helipad was significantly closer to ground level than its previous location on the Northland Medical ramp. The analyses showed that while periodic noise level increases were expected, and wind gusts were possible, neither of these impacts approached any safety threshold. St. Luke's representatives stated at the time that eventually the helipad would be relocated to the top of Building A, as this location would better suit hospital operations and be located further above the ground level.
- 2) In 2022, a MU-I Planning Review was completed for the long-planned vertical expansion of Building A; this added an "interstitial floor" of mechanicals as well as three additional levels with patient rooms. This expansion is currently under construction.
- 3) The current proposal involves removal of the helipad on top of the parking garage. A new helipad would be established on top of Building A, approximately 85' feet higher and 60' closer to the lake than the current helipad. This will result in fewer impacts to neighbors.
- 4) As Building A was constructed with plans for a future helipad, no additional structural support or roof access is needed. The helicopter landing area will be approximately 6' above the roof level, but this will be limited only to the landing site, and the overall height of the building will not change.
- 5) The building height with the expansion underway will be 111'. As Building A is located further than 200' from MU-N or any residential district, the maximum height allowed in this location is 300', provided that no more than 15% of St. Luke's property zoned MU-I may exceed 120'.
- 6) The only additional exterior lighting to be installed will be that lighting necessary to meet FAA regulations.
- 7) UDC sections including parking, landscaping, screening, and sustainability do not apply to this project.
- 8) No public, agency, or City comments have been received.
- 9) According to UDC 50-37.1.N, an approved Planning Review will expire if the project or activity authorized by the permit is not begun within 1 year.

Staff Recommendation

Based on the above findings, Staff recommends that Planning Commission approve the MU-I Planning Review with the following conditions:

- 1. The project be constructed, limited to, and maintained according to the plans and building elevations submitted with this application.
- 2. Any alterations to the approved plans that do not alter major elements of the plan may be approved by the Land Use Supervisor without further Planning Commission approval; however, no such administrative approval shall constitute a variance from the provisions of Chapter 50.




PL 24-006 Planning Review St. Luke's Hospital



The City of Duluth has tried to ensure that the information contained in this map or electronic document is accurate. The City of Duluth makes no warranty or guarantee concerning the accuracy or reliability. This drawing/data is neither a legally recorded map nor a survey and is not intended to be used as one. The drawing/data is a compilation of records, information and data located in various City, County and State offices and other sources affecting the area shown and is to be used for reference purposes only. The City of Duluth shall not be liable for errors contained within this data provided or for any damages in connection with the use of this information contained within





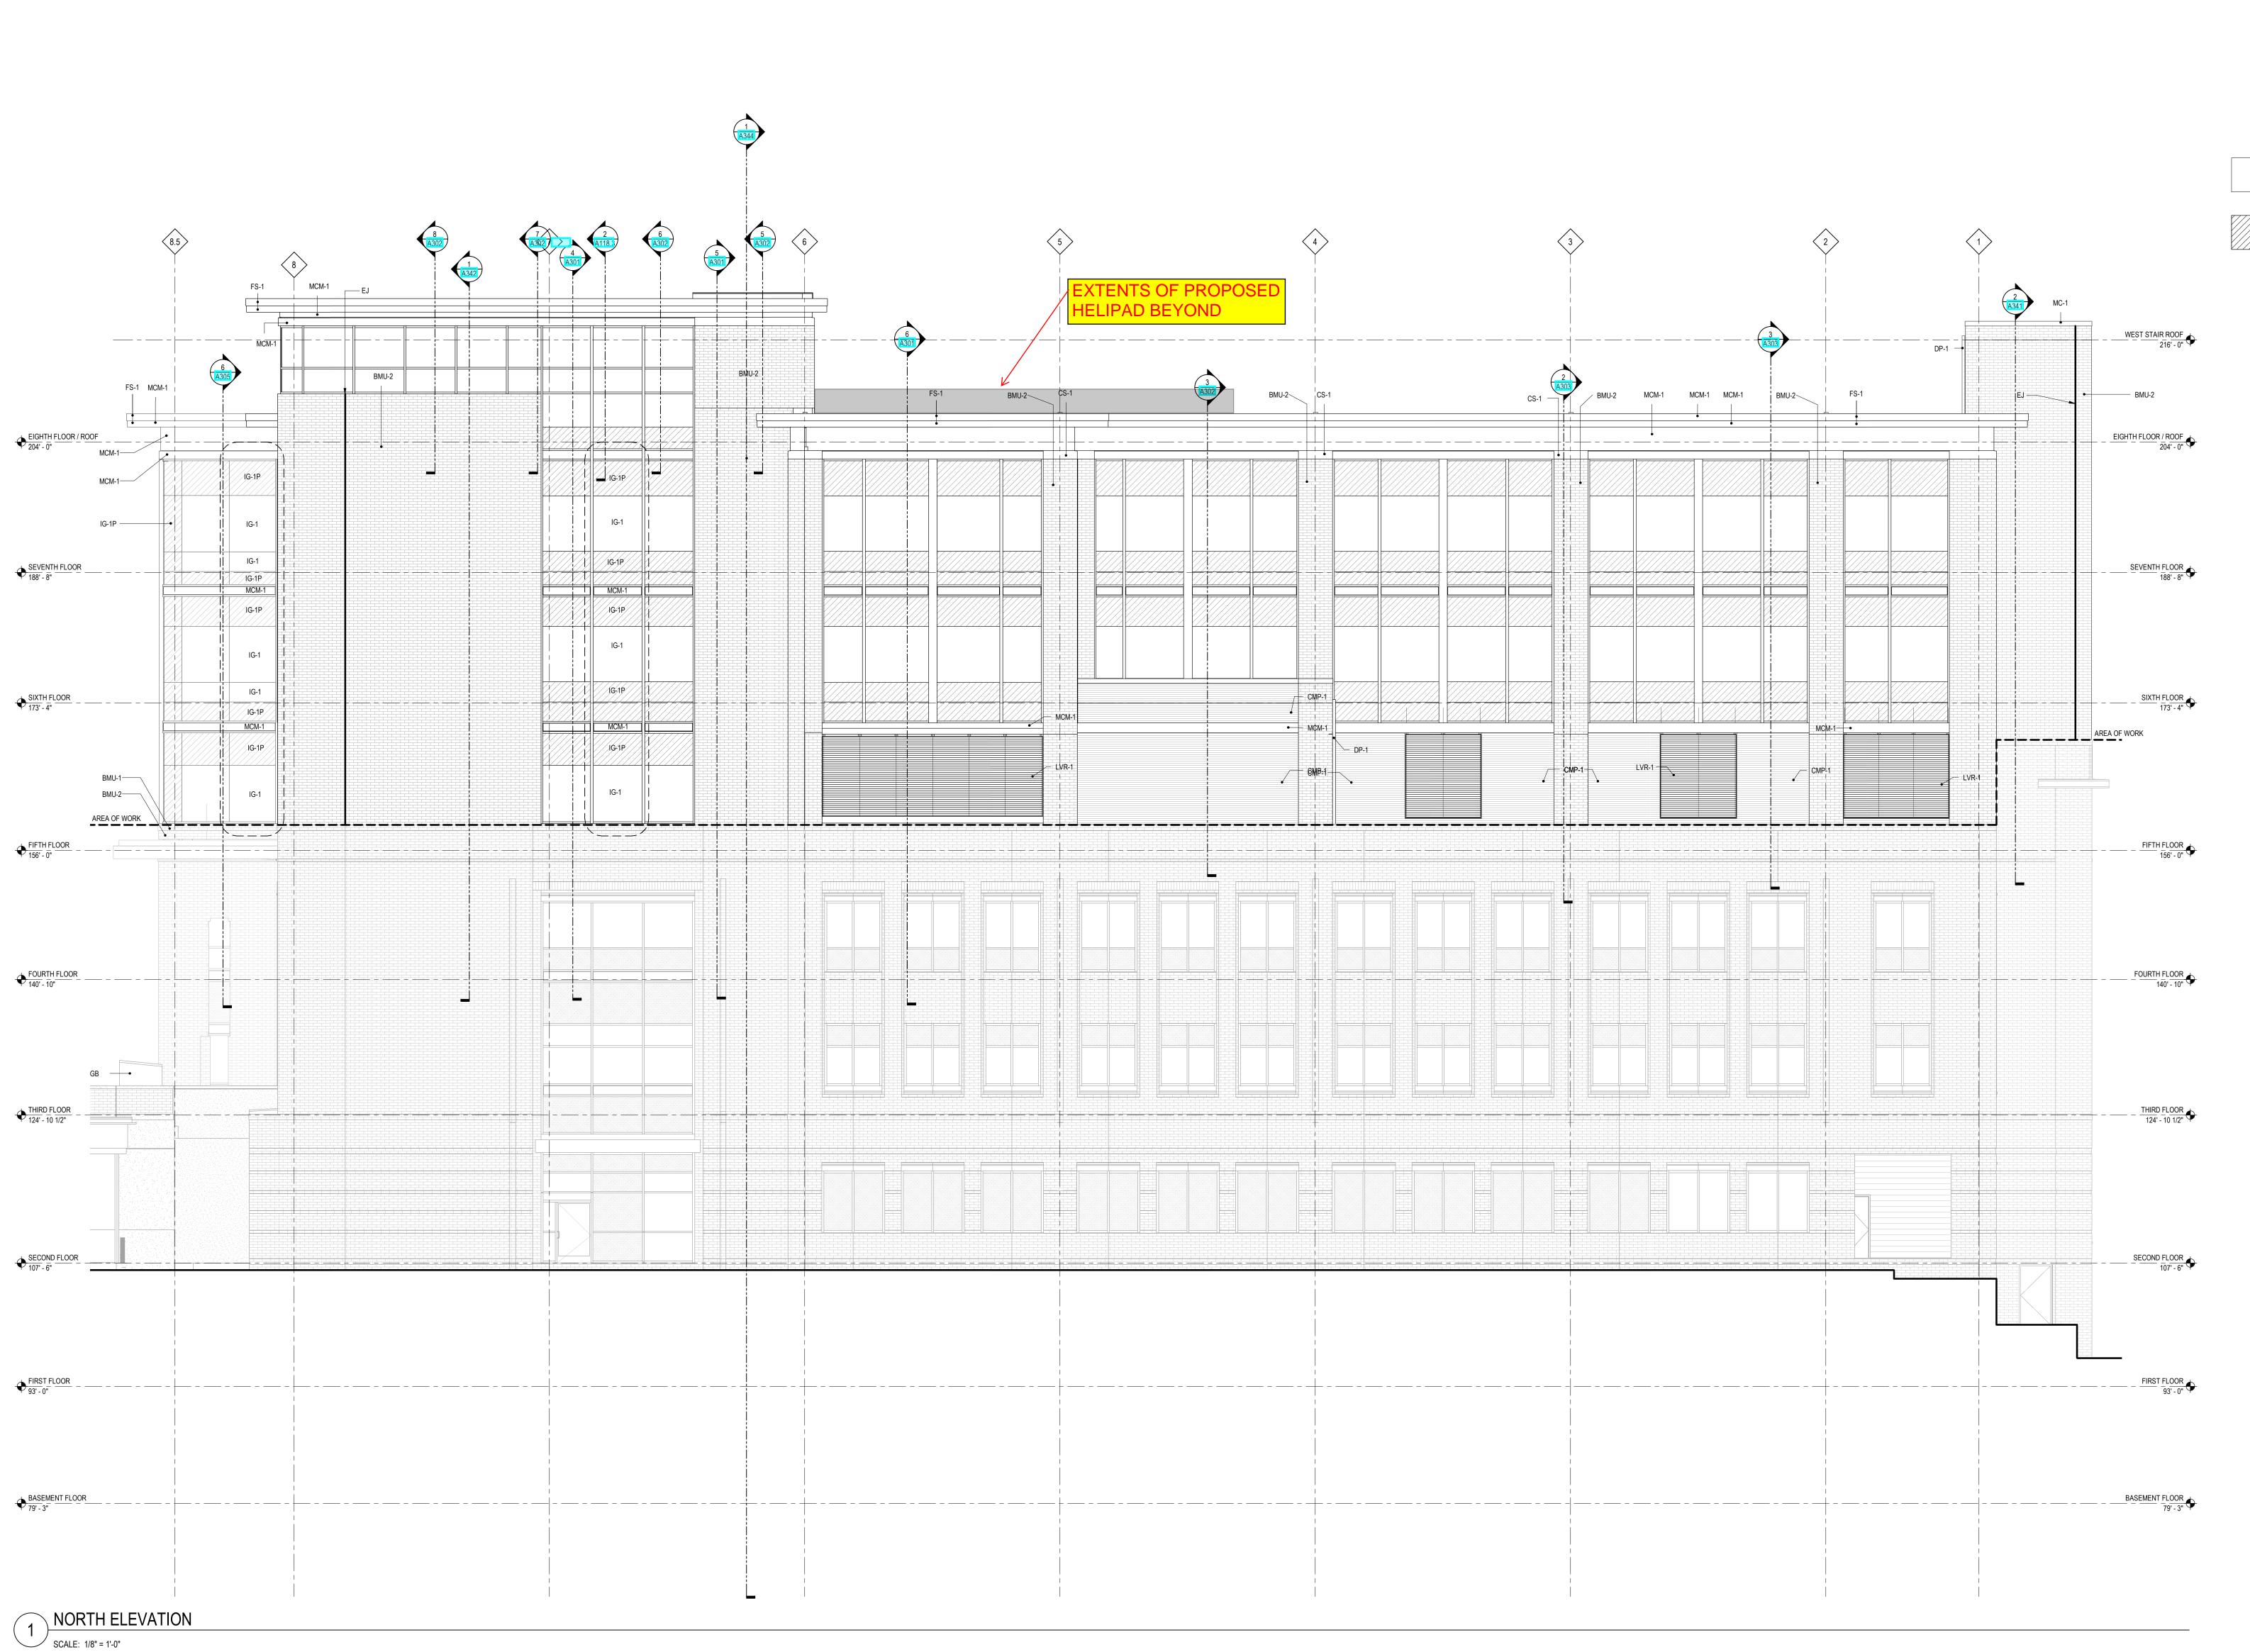

EXTERIOR MATERIALS

04 2000 - UNIT MASONRY
BMU-2 BRICK MASONRY UNIT - MATCH EXISTING

04 7300 - CAST STONE
CS-1 CAST STONE

072400 - EXTERIOR INSULATION AND FINISH SYSTEM - EIFS EIFS-1 MATCH EXISTING

EIFS-1 MATCH EXISTING

074213 - METAL WALL PANELS

CMP-1 CORRUGATED METAL PANEL - METALLIC SII

CMP-1 CORRUGATED METAL PANEL - METALLIC SILVER

074213.23 - ALUMINUM COMPOSITE METAL PANEL

MCM-1 ALUMINUM COMPOSITE METAL PANELS - SILVER

METALLIC MICA

NOTE:
ALIGN EIFS REVEALS WITH ARCHITECTURAL ELEMENTS AS SHOWN UNLESS NOTED OTHERWISE

077100 - MANUFACTURED ROOF SPECIALTIES

DS-1 DOWNSPOUT

ALUMINUM COPING CAP

MC-1 METAL COPING - METALLIC SILVER(MATCH EXISTING)

FS-1 ROOF EDGE FASCIA

084413 - GLAZED ALUMINUM CURTAINWALL
CW-1 X" ALUMINUM CURTAIN WALL SYSTEM
CW-2 X" ALUMINUM CURTAIN WALL SYSTEM
CWC-1 CURTAINWALL STRUCTURAL GLAZED MULLION

CWC-2 CURTAINWALL FULLY CAPTURED MULLION CAP
CWC-3 CURTAINWALL METAL PANEL FIN

MP-1 CURTAINWALL METAL PANEL INFILL

IG-1 VISION GLASS WITH LOW REFLECTIVITY

088000 - GLAZING

IG-1P SPANDREL GLASS WITH LOW REFLECTIVITY

08 9100 - LOUVERS

LVR-1 LOUVER

099100 - PAINTS
P-1 HIGH PERFORMANCE PAINT ON STEEL (TO MATCH ACM-1)

MISCELLANEOUS

CJ CONTROL JOINT

EJ EXPANSION JOINT

ERDMAN

One Erdman Place, Suite 300 Madison, Wisconsin 53717 Phone: (608) 410-8000

St.Luke

1012 E. SECOND ST.

DULUTH, MN. 53805

Architectural Services Provided **ERDMAN COMPANY**

Engineering Services Provided By:

ERDMAN COMPANY

Contractor Services Provided By: ERDMAN COMPANY Lic. No. IR652277

I hereby certify that this plan, specification, or report was prepared by me or under my direct supervision and that I am a duly Licensed Architect under the laws of the state of

Signature:

Minnesota.

Typed or Printed Name:

Daniel Wayne Delk Date:

07/28/2023

License Number:

2 CB004 07-28-23 1 PERMIT SET 01-30-23 No. Description Date


Document Release

Shoot No

EXTERIOR ELEVATION -NORTH

Drn:SRILEY Chk:TDU

Sheet Number
A201

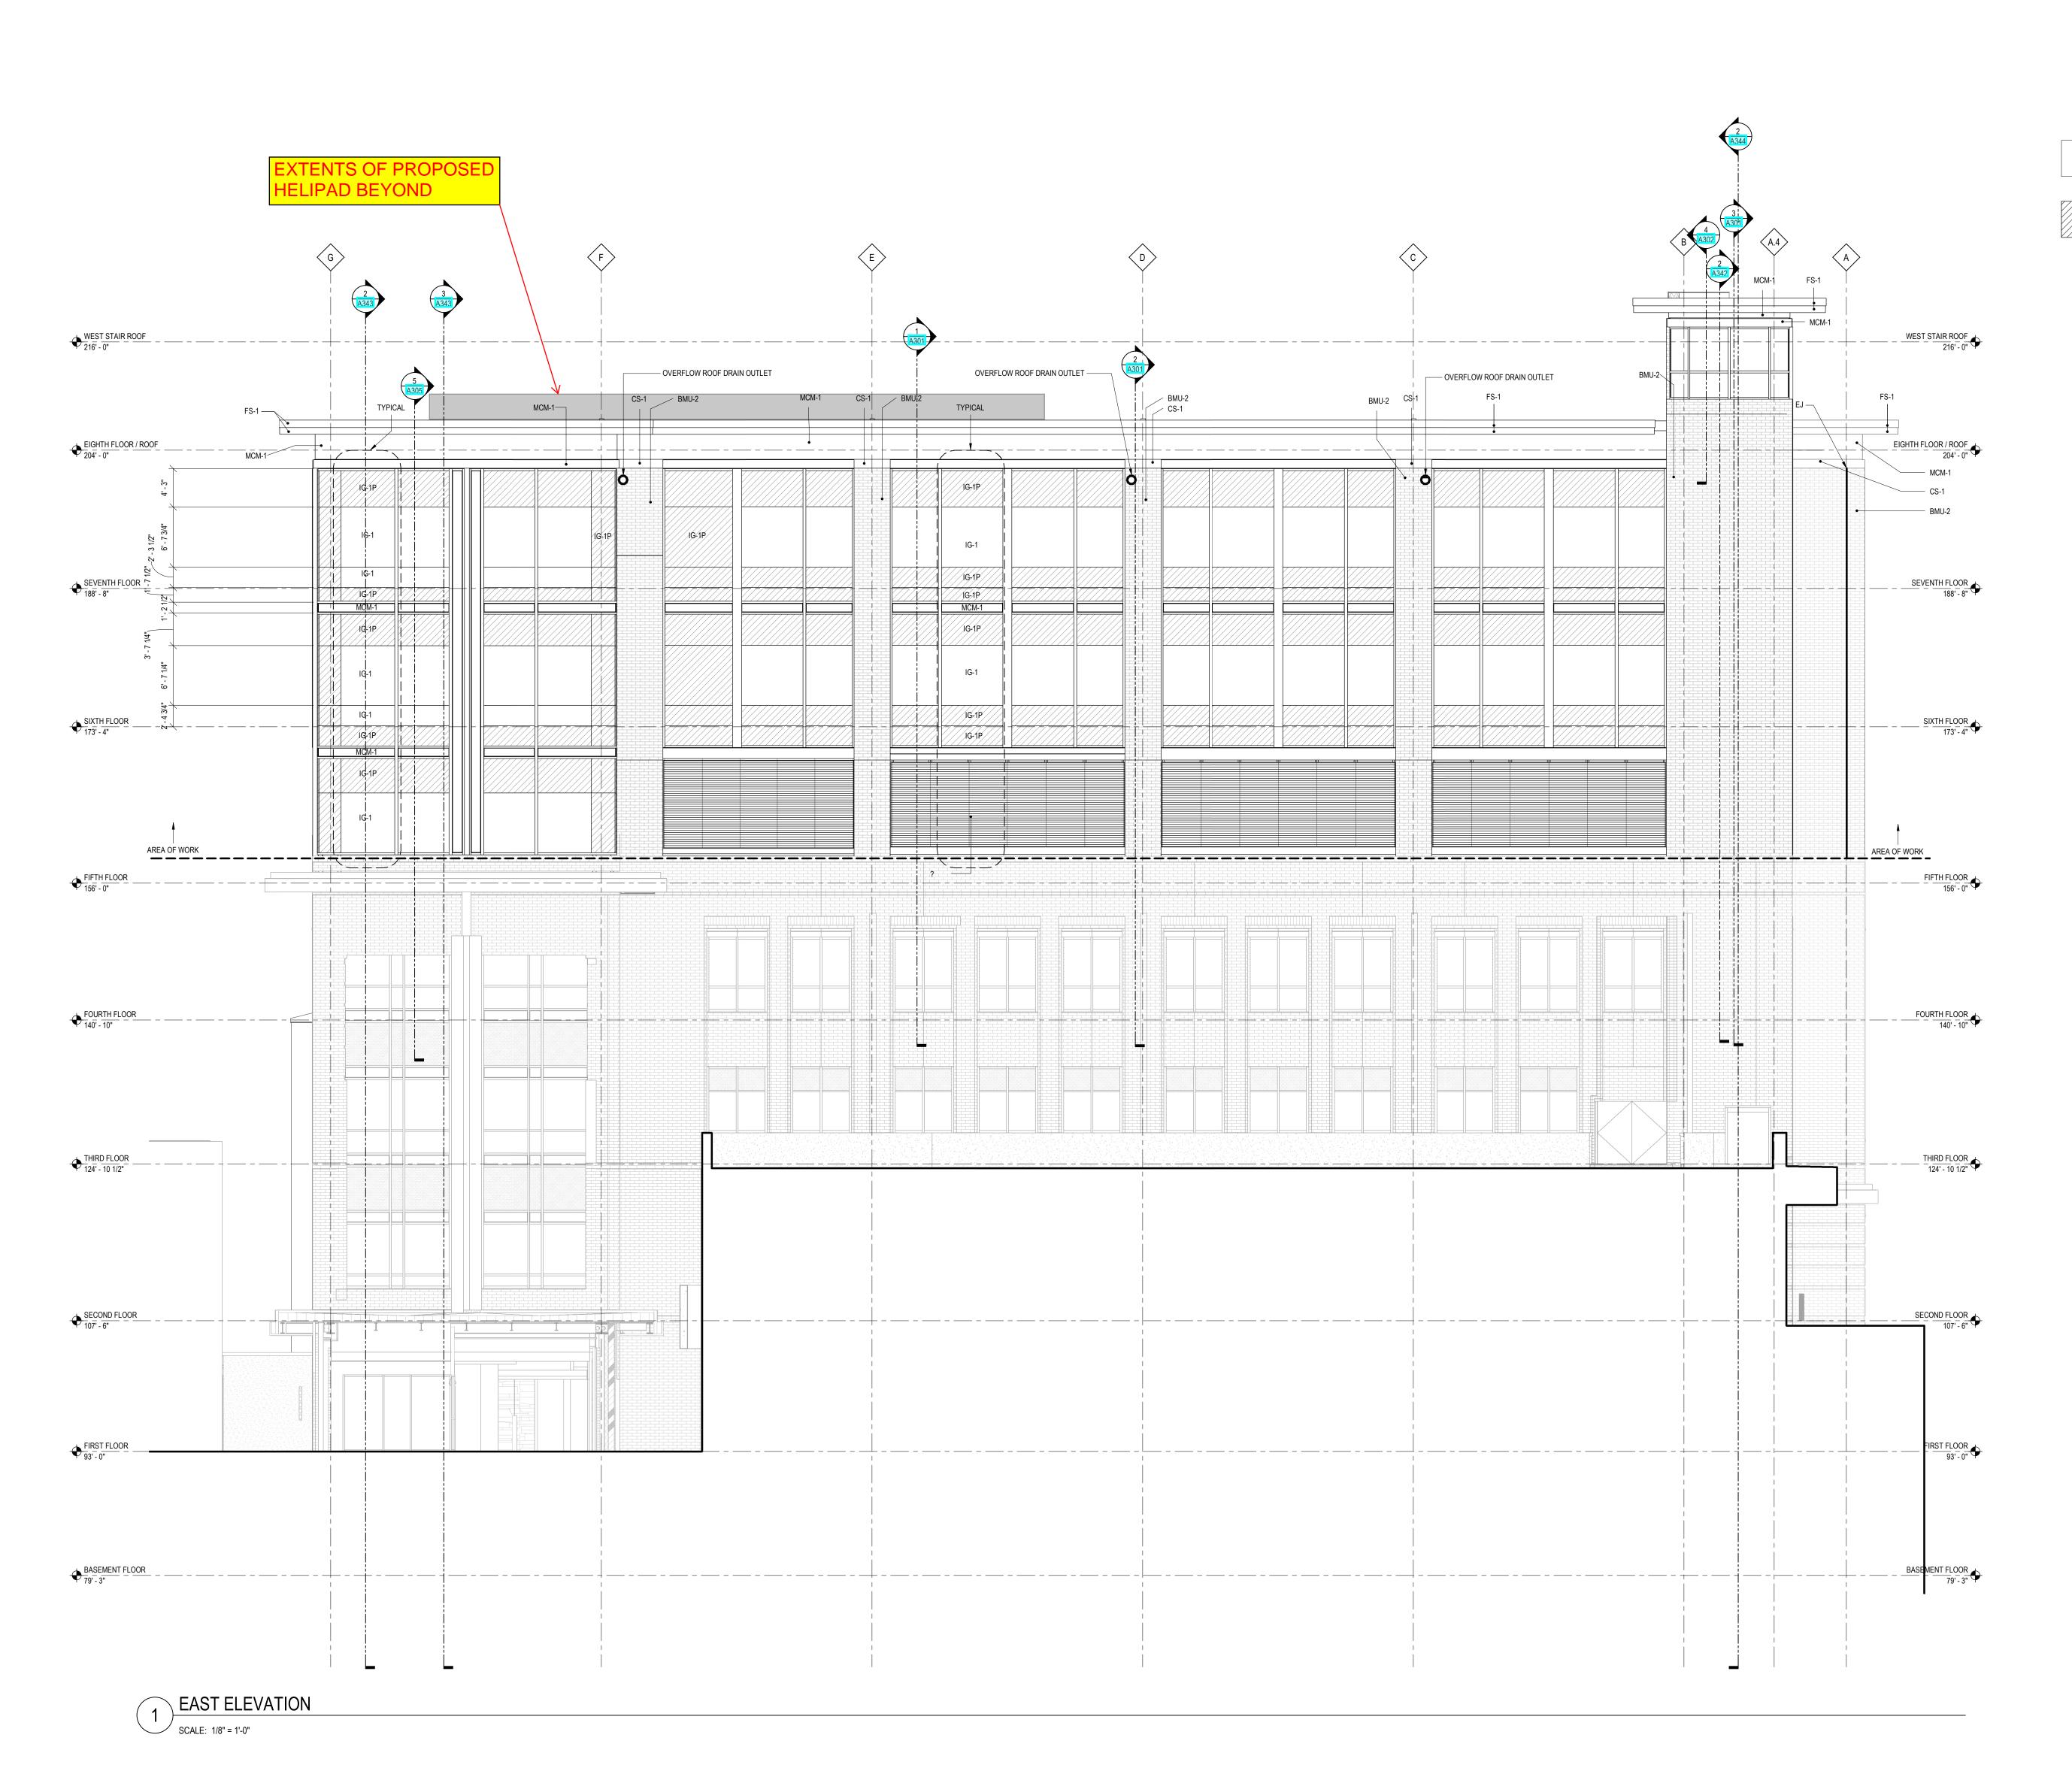

EXTERIOR MATERIALS

04 2000 - UNIT MASONRY
BMU-2 BRICK MASONRY UNIT - MATCH EXISTING

04 7300 - CAST STONE
CS-1 CAST STONE

072400 - EXTERIOR INSULATION AND FINISH SYSTEM - EIFS
EIFS-1 MATCH EXISTING

074213 - METAL WALL PANELS
CMP-1 CORRUGATED METAL PANEL - METALLIC SILVER
074213.23 - ALUMINUM COMPOSITE METAL PANEL

MCM-1 ALUMINUM COMPOSITE METAL PANELS - SILVER
METALLIC MICA

NOTE:
ALIGN EIFS REVEALS WITH ARCHITECTURAL ELEMENTS AS
SHOWN UNLESS NOTED OTHERWISE

077100 - MANUFACTURED ROOF SPECIALTIES
DS-1 DOWNSPOUT
ALUMINUM COPING CAP

MC-1 METAL COPING - METALLIC SILVER(MATCH EXISTING)
FS-1 ROOF EDGE FASCIA

084413 - GLAZED ALUMINUM CURTAINWALL

CW-1 X" ALUMINUM CURTAIN WALL SYSTEM
CW-2 X" ALUMINUM CURTAIN WALL SYSTEM

CWC-1 CURTAINWALL STRUCTURAL GLAZED MULLION
CAP
CWC-2 CURTAINWALL FULLY CAPTURED MULLION CAP
CWC-3 CURTAINWALL METAL PANEL FIN

MP-1 CURTAINWALL METAL PANEL INFILL

088000 - GLAZING

IG-1 VISION GLASS WITH LOW REFLECTIVITY

IG-1P SPANDREL GLASS WITH LOW REFLECTIVITY

08 9100 - LOUVERS

LVR-1 LOUVER

P-1 HIGH PERFORMANCE PAINT ON STEEL (TO

MISCELLANEOUS

CJ CONTROL JOINT

EJ EXPANSION JOINT

MATCH ACM-1)

ERDMAN

One Erdman Place, Suite 300 Madison, Wisconsin 53717 Phone: (608) 410-8000



1012 E. SECOND ST.

ERDMAN COMPANY

ERDMAN COMPANY

DULUTH, MN. 53805

Architectural Services Provided

Engineering Services Provided By:

Contractor Services Provided By: ERDMAN COMPANY Lic. No. IR652277

I hereby certify that this plan, specification, or report was prepared by me or under my direct supervision and that I am a duly Licensed Architect under the laws of the state of

Signature:

Minnesota.

Del Waye Dell Typed or Printed Name:

Date:

Daniel Wayne Delk

07/28/2023 License Number:

. . . .

 2
 CB004
 07-28-23

 1
 PERMIT SET
 01-30-23

 No.
 Description
 Date


 Document Release

EXTERIOR
ELEVATION -

EAST

Drn:SRILEY Chk:TDUH
Sheet Number

A203

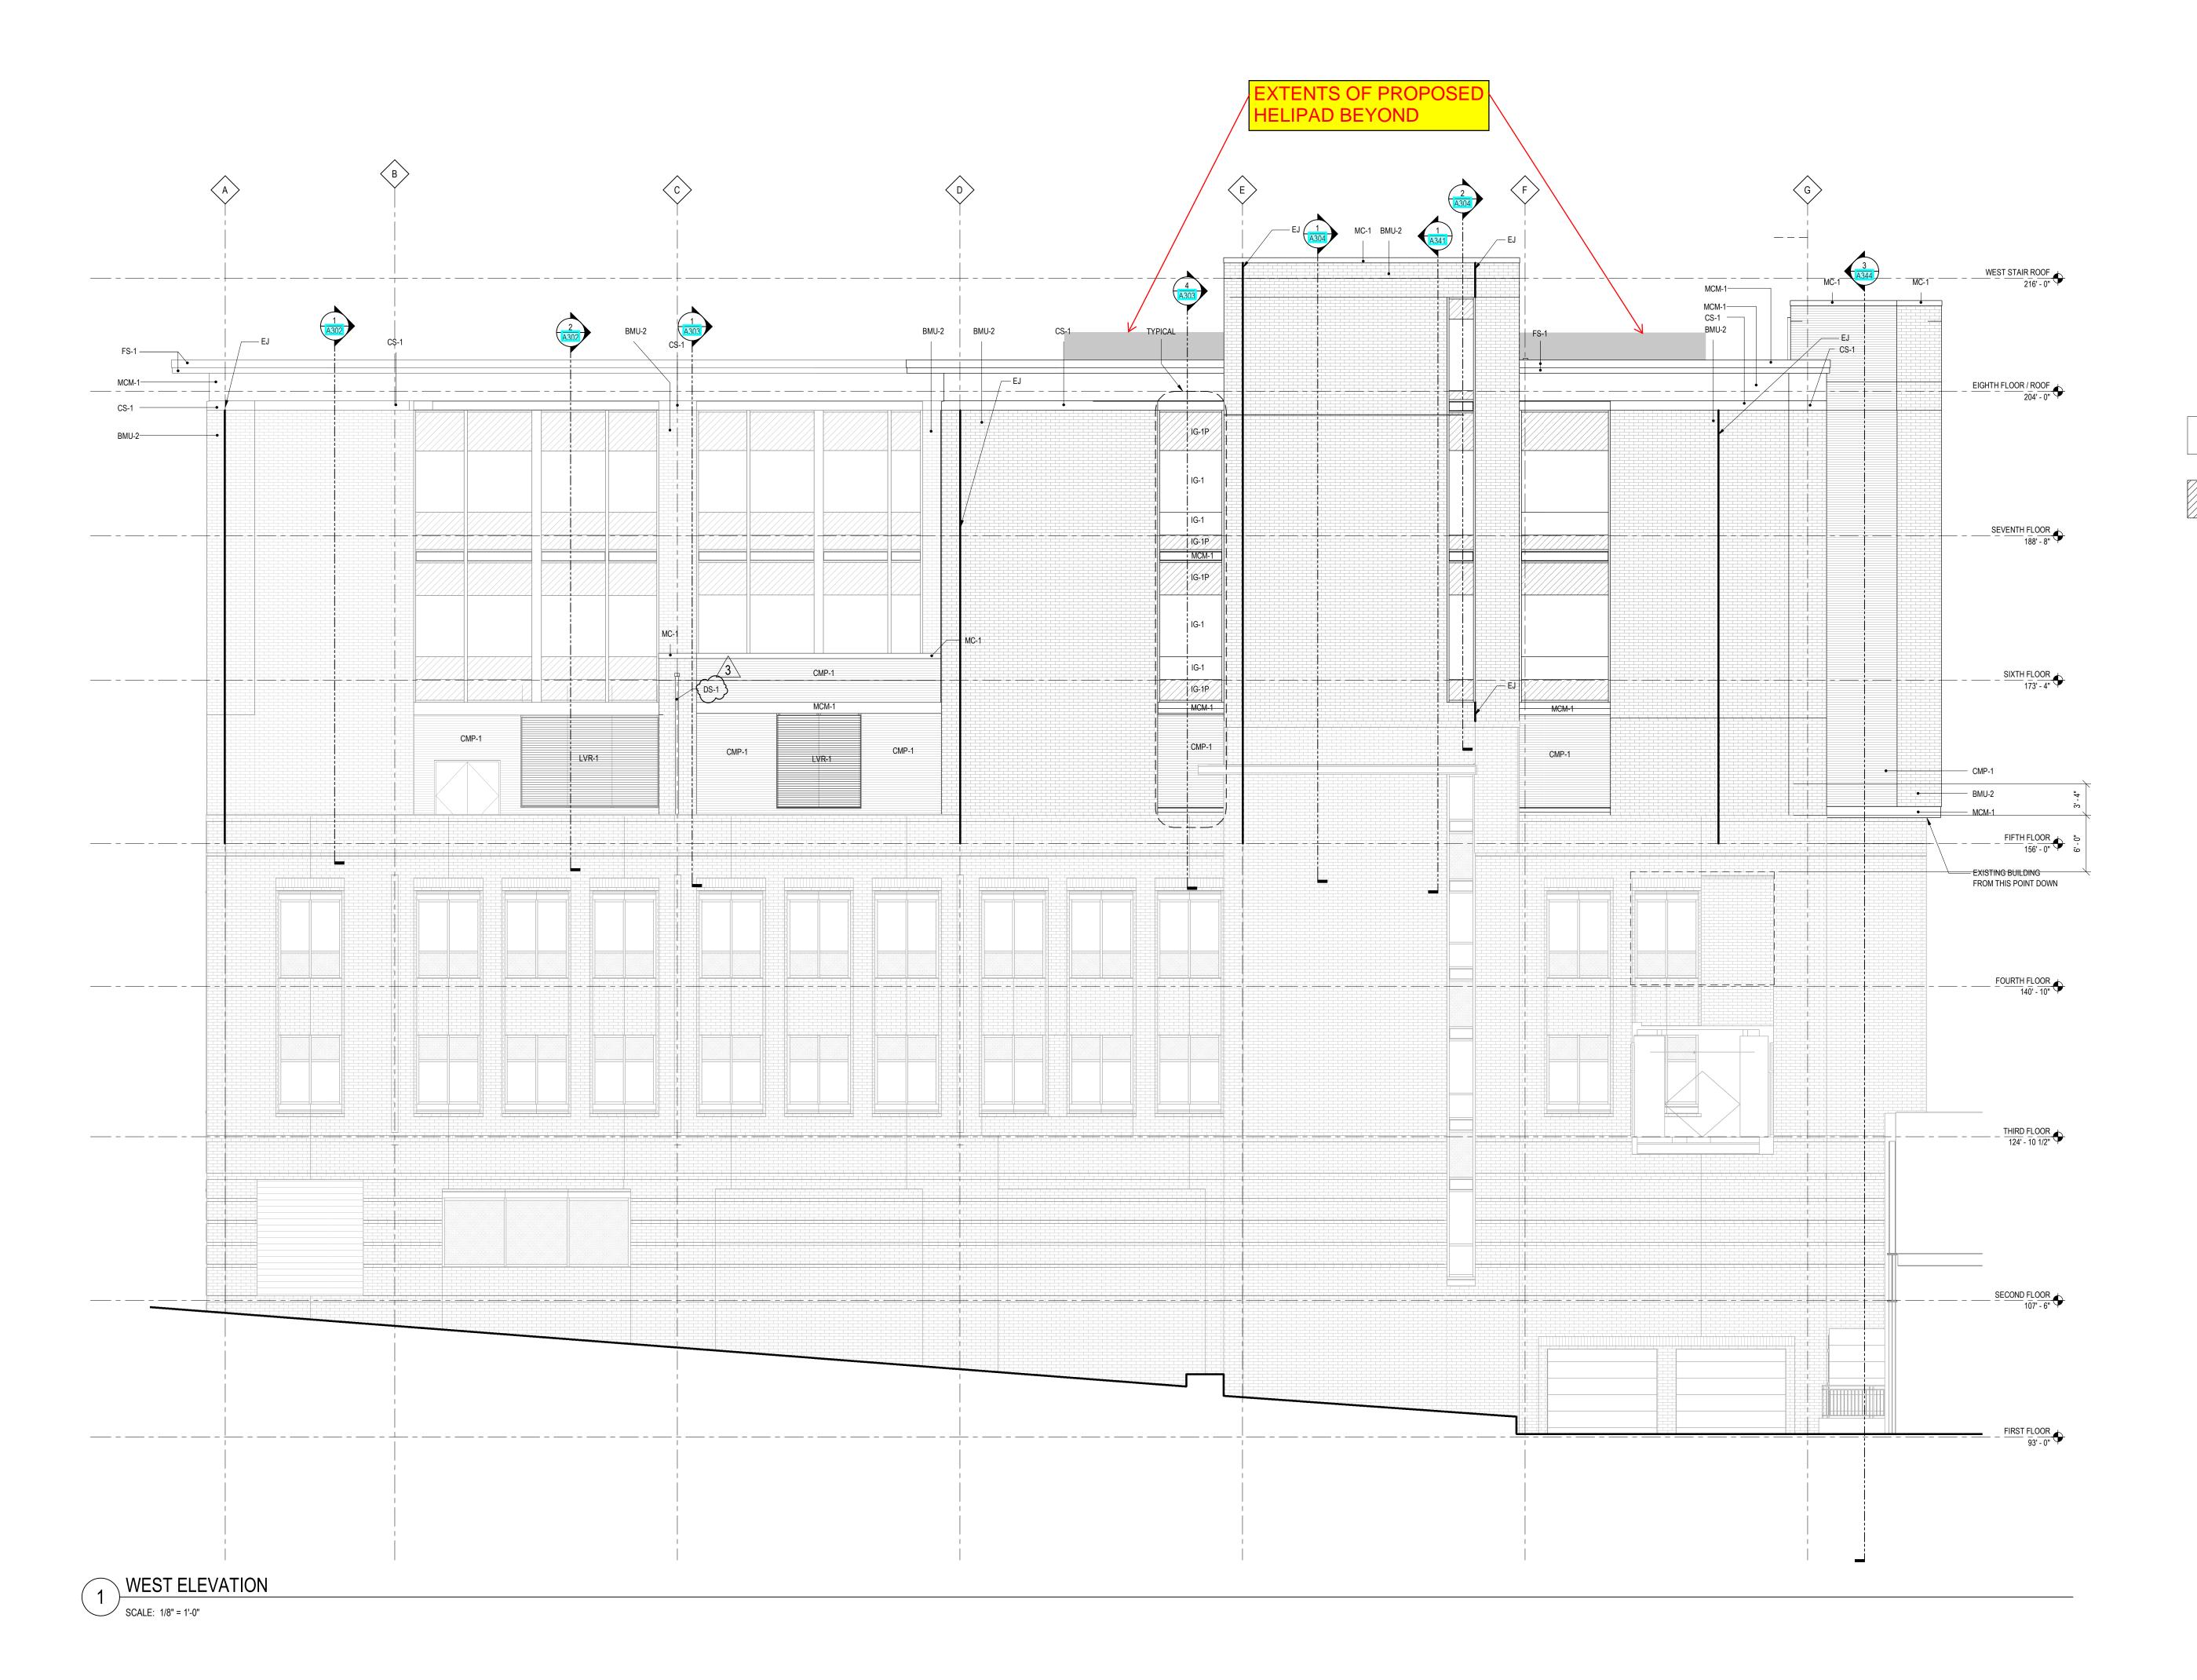

EXTERIOR MATERIALS

04 2000 - UNIT MASONRYBMU-2 BRICK MASONRY UNIT - MATCH EXISTING 04 7300 - CAST STONE

CS-1 CAST STONE 072400 - EXTERIOR INSULATION AND FINISH SYSTEM - EIFS EIFS-1 MATCH EXISTING

074213 - METAL WALL PANELS CMP-1 CORRUGATED METAL PANEL - METALLIC SILVER 074213.23 - ALUMINUM COMPOSITE METAL PANEL MCM-1 ALUMINUM COMPOSITE METAL PANELS - SILVER
METALLIC MICA

ALIGN EIFS REVEALS WITH ARCHITECTURAL ELEMENTS AS SHOWN UNLESS NOTED OTHERWISE

077100 - MANUFACTURED ROOF SPECIALTIES DS-1 DOWNSPOUT ALUMINUM COPING CAP MC-1 METAL COPING - METALLIC SILVER(MATCH

FS-1 ROOF EDGE FASCIA 084413 - GLAZED ALUMINUM CURTAINWALL CW-1 X" ALUMINUM CURTAIN WALL SYSTEM
CW-2 X" ALUMINUM CURTAIN WALL SYSTEM

CWC-1 CURTAINWALL STRUCTURAL GLAZED MULLION

CWC-2 CURTAINWALL FULLY CAPTURED MULLION CAP CWC-3 CURTAINWALL METAL PANEL FIN MP-1 CURTAINWALL METAL PANEL INFILL 088000 - GLAZING

VISION GLASS WITH LOW REFLECTIVITY

IG-1P SPANDREL GLASS WITH LOW REFLECTIVITY 08 9100 - LOUVERS

LVR-1 LOUVER P-1 HIGH PERFORMANCE PAINT ON STEEL (TO MATCH ACM-1)

MISCELLANEOUS
CONTROL JOINT
CYPANSION JO **EXPANSION JOINT**

One Erdman Place, Suite 300 Madison, Wisconsin 53717 Phone: (608) 410-8000



1012 E. SECOND ST. DULUTH, MN. 53805

ERDMAN COMPANY

Architectural Services Provided By:

Engineering Services Provided By: ERDMAN COMPANY

Contractor Services Provided By: ERDMAN COMPANY Lic. No. IR652277

I hereby certify that this plan, specification, or report was prepared by me or under my direct supervision and that I am a duly Licensed Architect under the laws of the state of Minnesota.

Dail Wayne Delle Typed or Printed Name:


Daniel Wayne Delk

07/28/2023 License Number:

12-18-23 07-28-23 Description

Document Release

EXTERIOR ELEVATION -WEST

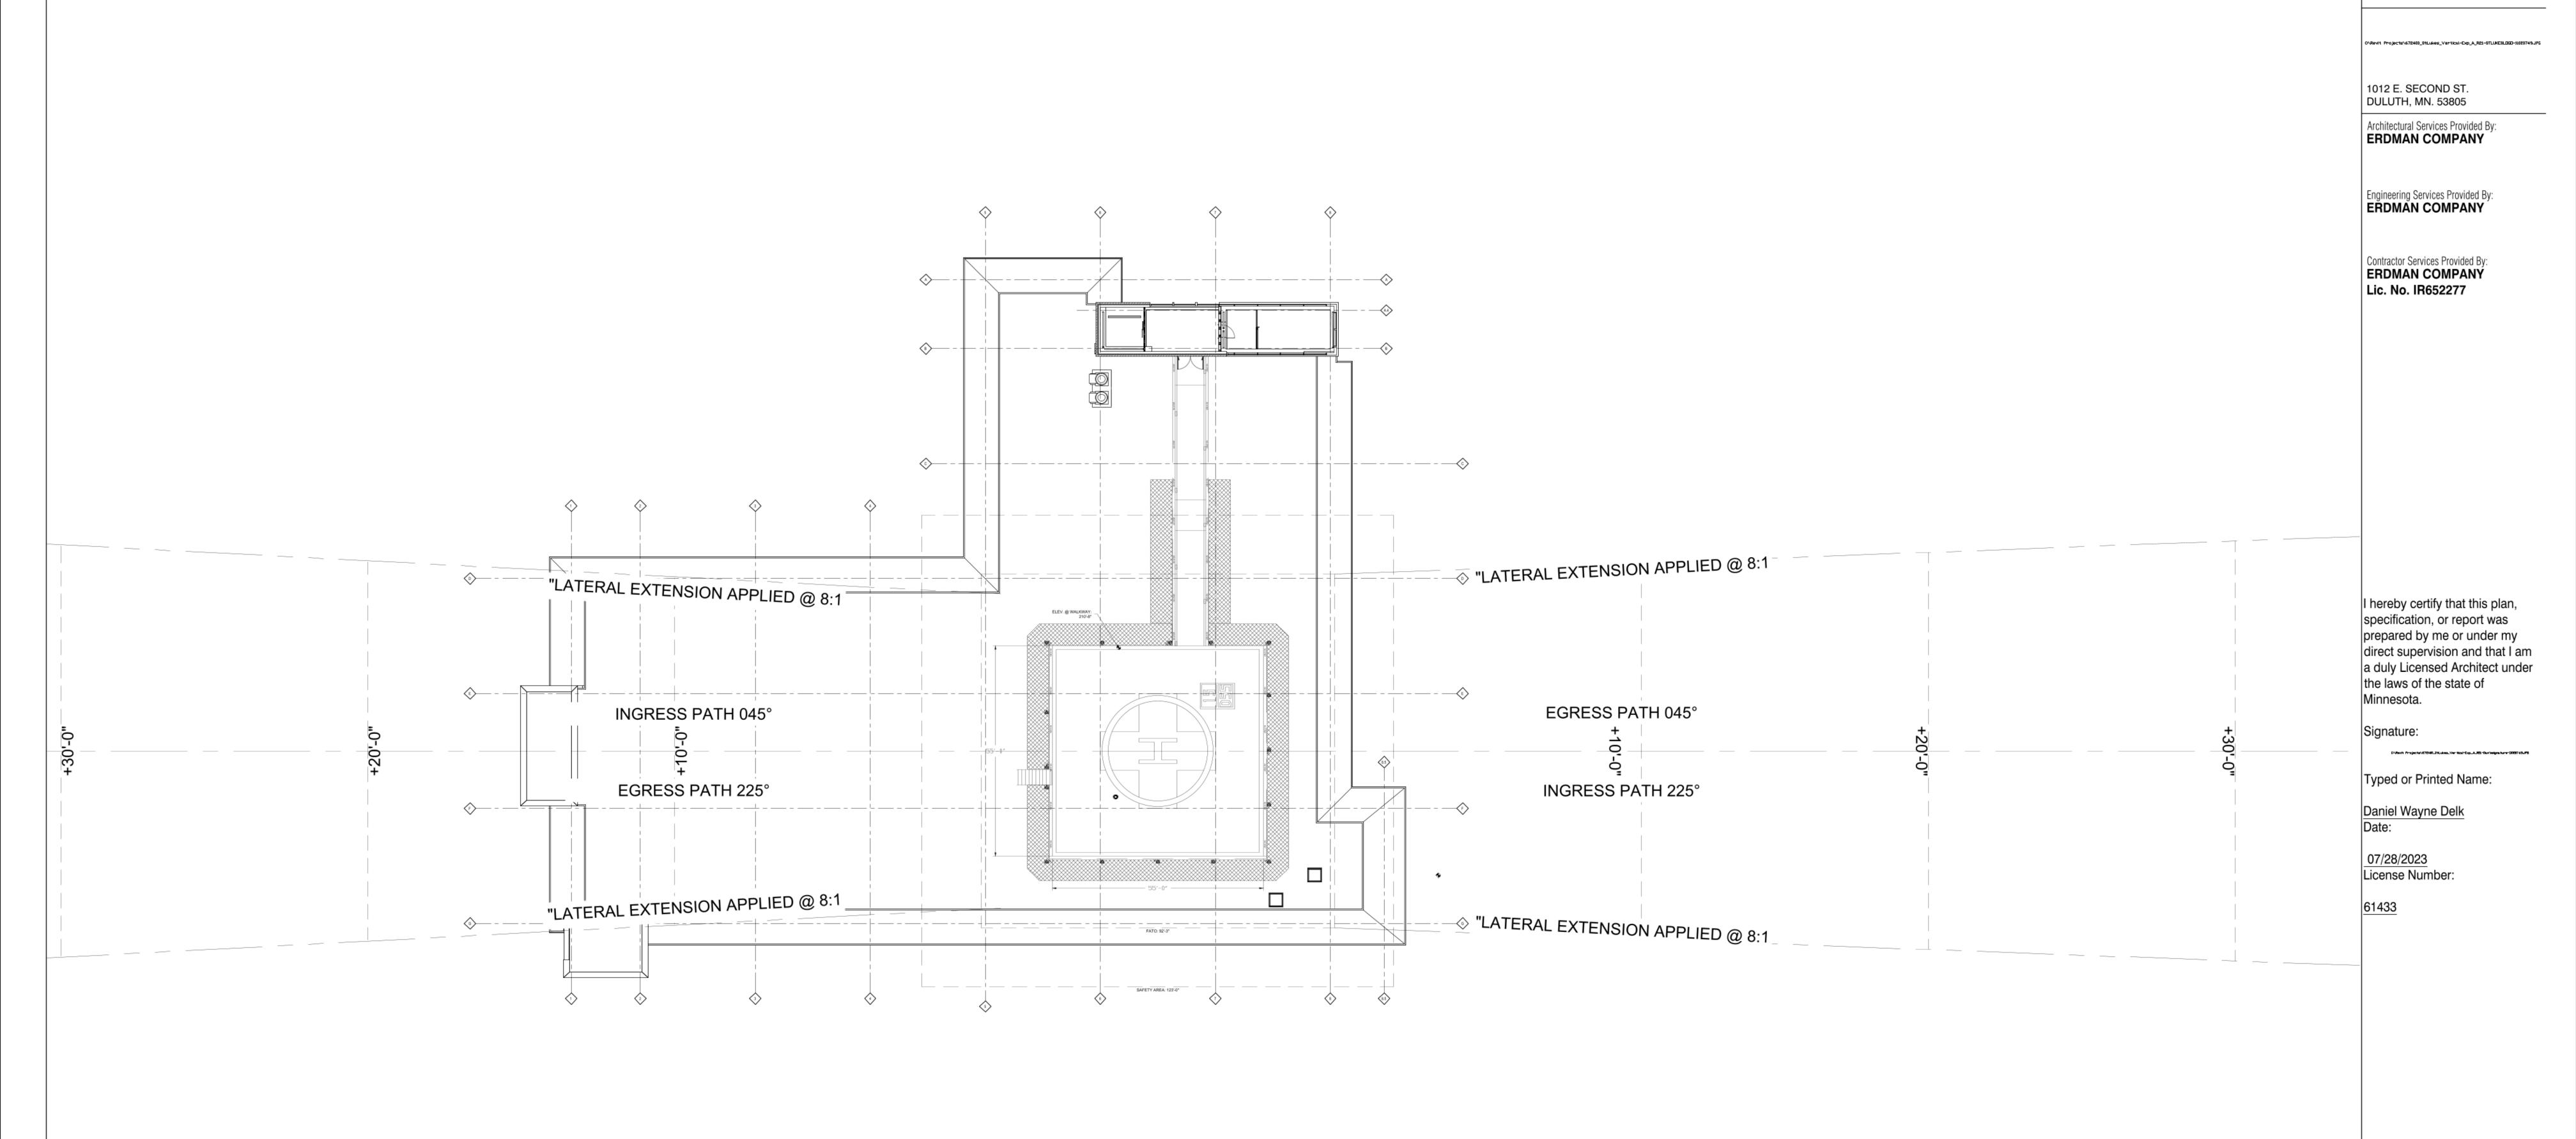

2 CB004 07-28-23
1 PERMIT SET 01-30-23
No. Description Date

Document Release

DARevit Projects1678480_StLukes_Ventical=Exp_A_RPI=title_black_lago=697933.jpg

One Erdman Place, Suite 300 Madison, Wisconsin 53717 Phone: (608) 410-8000

HELIPAD DATA

DESIGN AIRCRAFT CRITERIA

TYPE: AW-139

TYPF:OVERALL LENGTH: 54.7'

ROTOR DIA: 41.6'

MAX TAKEOFF WEIGHT: 15,000 lbs

HELIPAD DIMENSIONS & LOCATION

ACTUAL TLOF: 55'

ACTUAL FATO: 92'-3"

ACTUAL SAFETY AREA: 123'-0"

LAT: 42° 57' 13"

LONG: 85° 37' 23"

APPROACH/DEPARTURE INGRESS: 225°/045°(TRUE) DEGRESS: 225°/045°(TRUE)

> <u>HELIPAD SURFACE</u> TYPE: ALUMINUM

PREVAILING WINDS DIRECT1: WNW DIRECT2: WSW Sheet Name

HELISTOP FLIGHT PATH ARRANGEMENT

Drn: DTB Chk: JJS
Sheet Number

H-1

HELISTOP FLIGHT PATH ARRANGEMENT

SCALE: 1/16" = 1'-0"

GENERAL NOTES:

1) HELISTOP DIMENSIONS AND CLEARANCES ARE BASED ON FAA AC 150/5390-2D REQUIREMENTS FOR AN AUGUSTA AW-139 AS THE DESIGN HELICOPTER

2) VFR APPROACH/DEPARTURE SLOPE 8:1, TRANSITION SURFACE 2:1

3) HELISTOP LIGHTING LAYOUT TO MEET FAA ACC 150/5390-2D, CHAPTER.2 SEE SHEETS E-1, E-2, AND E-3, E-4,E-5, AND E-6 FOR DETAILS

4) HELISTOP DECK MARKINGS AND OTHER PAINT SCHEMES TO MEET FAA AC 150/5390-2D CHAPTER.2 SEE PA-1 AND PA-2 FOR DETAILS

5) HELISTOP SAFETY NET EQUIPMENT TO BE DESIGNATED TO MEET AND/OR EXCEED FAA AC 150*5390-2D, CHAPTER.2, AND BUILDING CODE THAT APPLIES. SEE SHEETS SN-1 THROUGH SN-6 FOR DETAILS

1) FUEL/WATER SEPARATOR, FEC PART NO. HP0285 TO BE SUPPORTED FROM HELISTOP STRUCTURAL STEEL. SEE SHEETS P-1,P-2 AND P-3 FOR DETAILS OF THE FUEL/WATER SEPARATOR

2) AFFF FOAM FIRE SUPPRESSION SKID, FEC PART NO. HP0296, TO BE LOCATED IN HEATED MECHANICAL SPACE. SEE SHEET FS-1,FS-2 AND FS-3

3) HYDRONIC SNOWMELT SYSTEM, FEC PART NO. HPO300-2S, HP0300-2H TO BE LOCATED IN HEATED MECHANICAL SPACE. SEE SHEETS SM-1,SM-2 AND SM-3 FOR DETAILS.

4) ALL HORIZONTAL STEEL FOR DECK AND WALKWAY TO BE DESIGNED BY FEC VERTICAL SUPPORT STEEL FOR DECK AND WALKWAY TO BE DESIGNED AND PROVIDED BY OTHERS

DARevit Projects\6784ID.StLukes_Ventical=Exp_A_RPI=title_black_lago=897933.jpg

One Erdman Place, Suite 300 Madison, Wisconsin 53717 Phone: (608) 410-8000

C\Revit Projects\672400_StLukes_Vertical-Exp_A_R21-STLUKESLDGD-1028749.JPG

1012 E. SECOND ST. DULUTH, MN. 53805

Architectural Services Provided By: **ERDMAN COMPANY**

Engineering Services Provided By: ERDMAN COMPANY

Contractor Services Provided By: ERDMAN COMPANY Lic. No. IR652277

I hereby certify that this plan, specification, or report was prepared by me or under my direct supervision and that I am a duly Licensed Architect under the laws of the state of Minnesota.

|Signature:

Typed or Printed Name:

Daniel Wayne Delk


07/28/2023 License Number:

Description Document Release


HELISTOP **GENERAL ARRANGEMENT**

→ HELISTOP GENERAL ARRANGEMENT


SCALE: 1/16" = 1'-0"

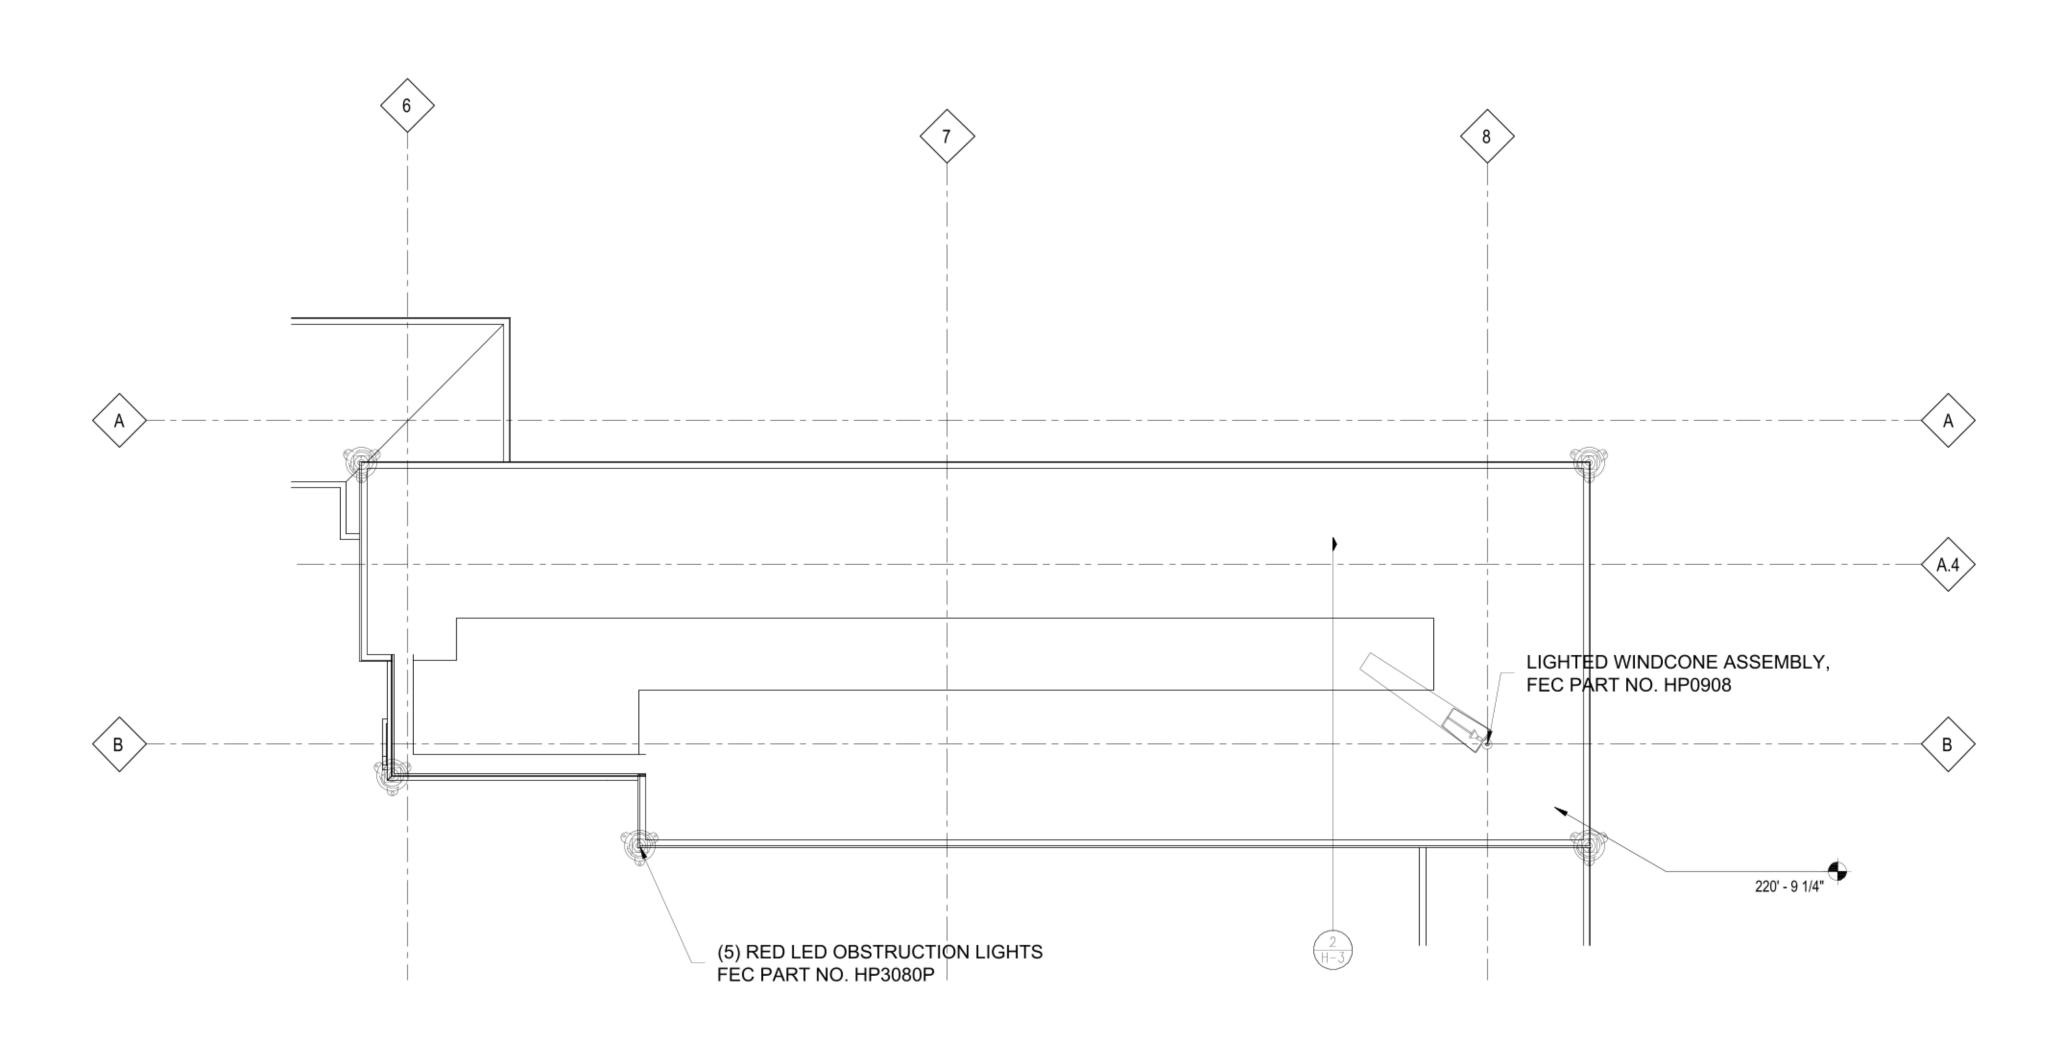

(1) ELEVATOR PENTHOUSE ROOF H-3)

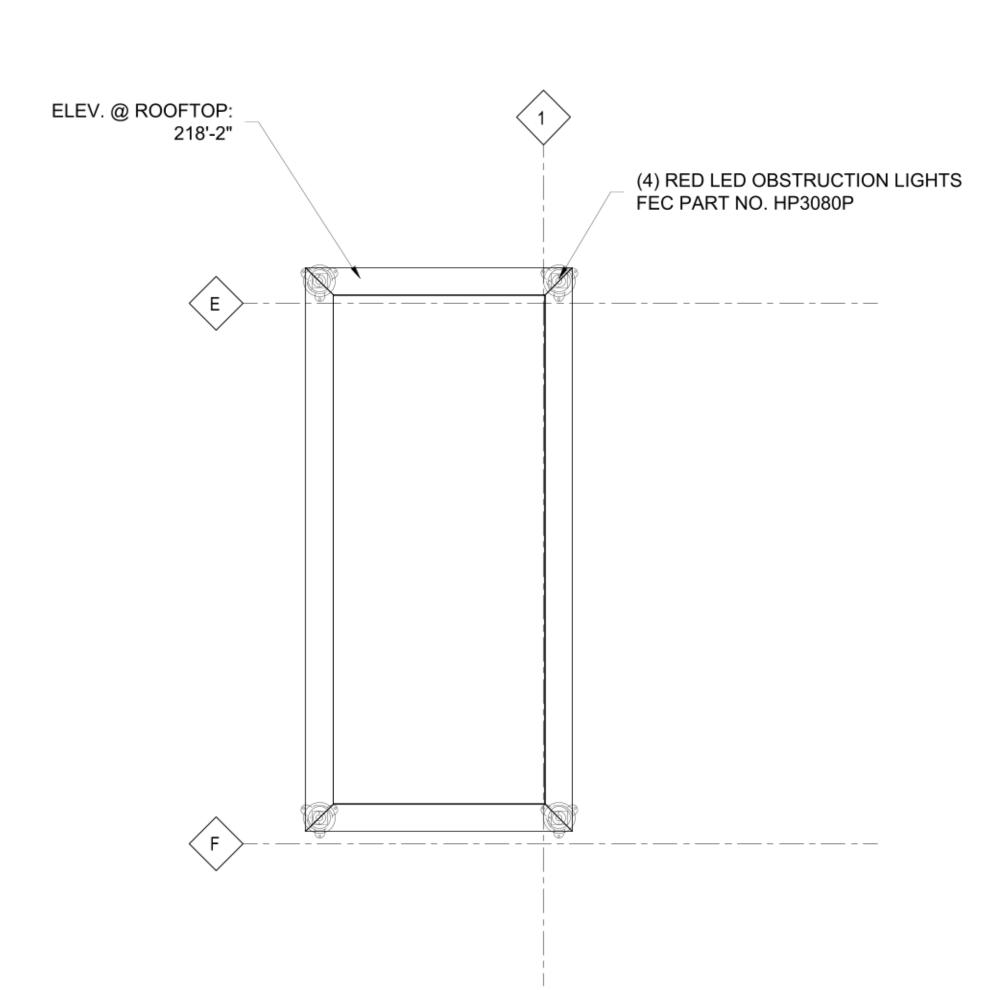

EXIT STAIRCASE TOWER

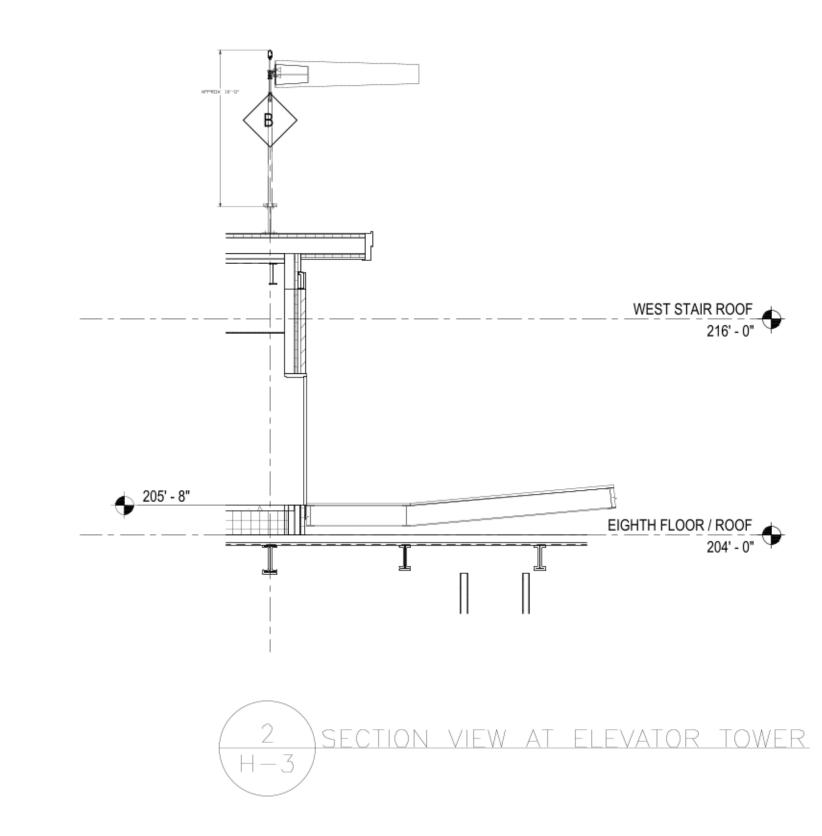

C/Nervit Projects/678400_XtLukes_Ventical=Exp_A_RSI=title_block_logo=277533.jpg

One Erdman Place, Suite 300 Madison, Wisconsin 53717 Phone: (608) 410-8000

C/Revit Projects\672400_StLukes_Vertical-Exp_A_R2I-STLUKESL060-33020749.JPG

1012 E. SECOND ST. DULUTH, MN. 53805

Architectural Services Provided By: **ERDMAN COMPANY**

Engineering Services Provided By: ERDMAN COMPANY

Contractor Services Provided By: ERDMAN COMPANY Lic. No. IR652277

I hereby certify that this plan, specification, or report was prepared by me or under my direct supervision and that I am a duly Licensed Architect under the laws of the state of Minnesota.

Signature: SVMexit Projects/670H9L2Hukes_VerHost-Cop_AUSS-Deviseigns/sare-1993765uF0

Typed or Printed Name:

Daniel Wayne Delk


07/28/2023 License Number:

61433

Description Document Release

HELISTOP **ARRANGEMENT AT ROOF**

HELISTOP ARRANGEMENT AT ROOF

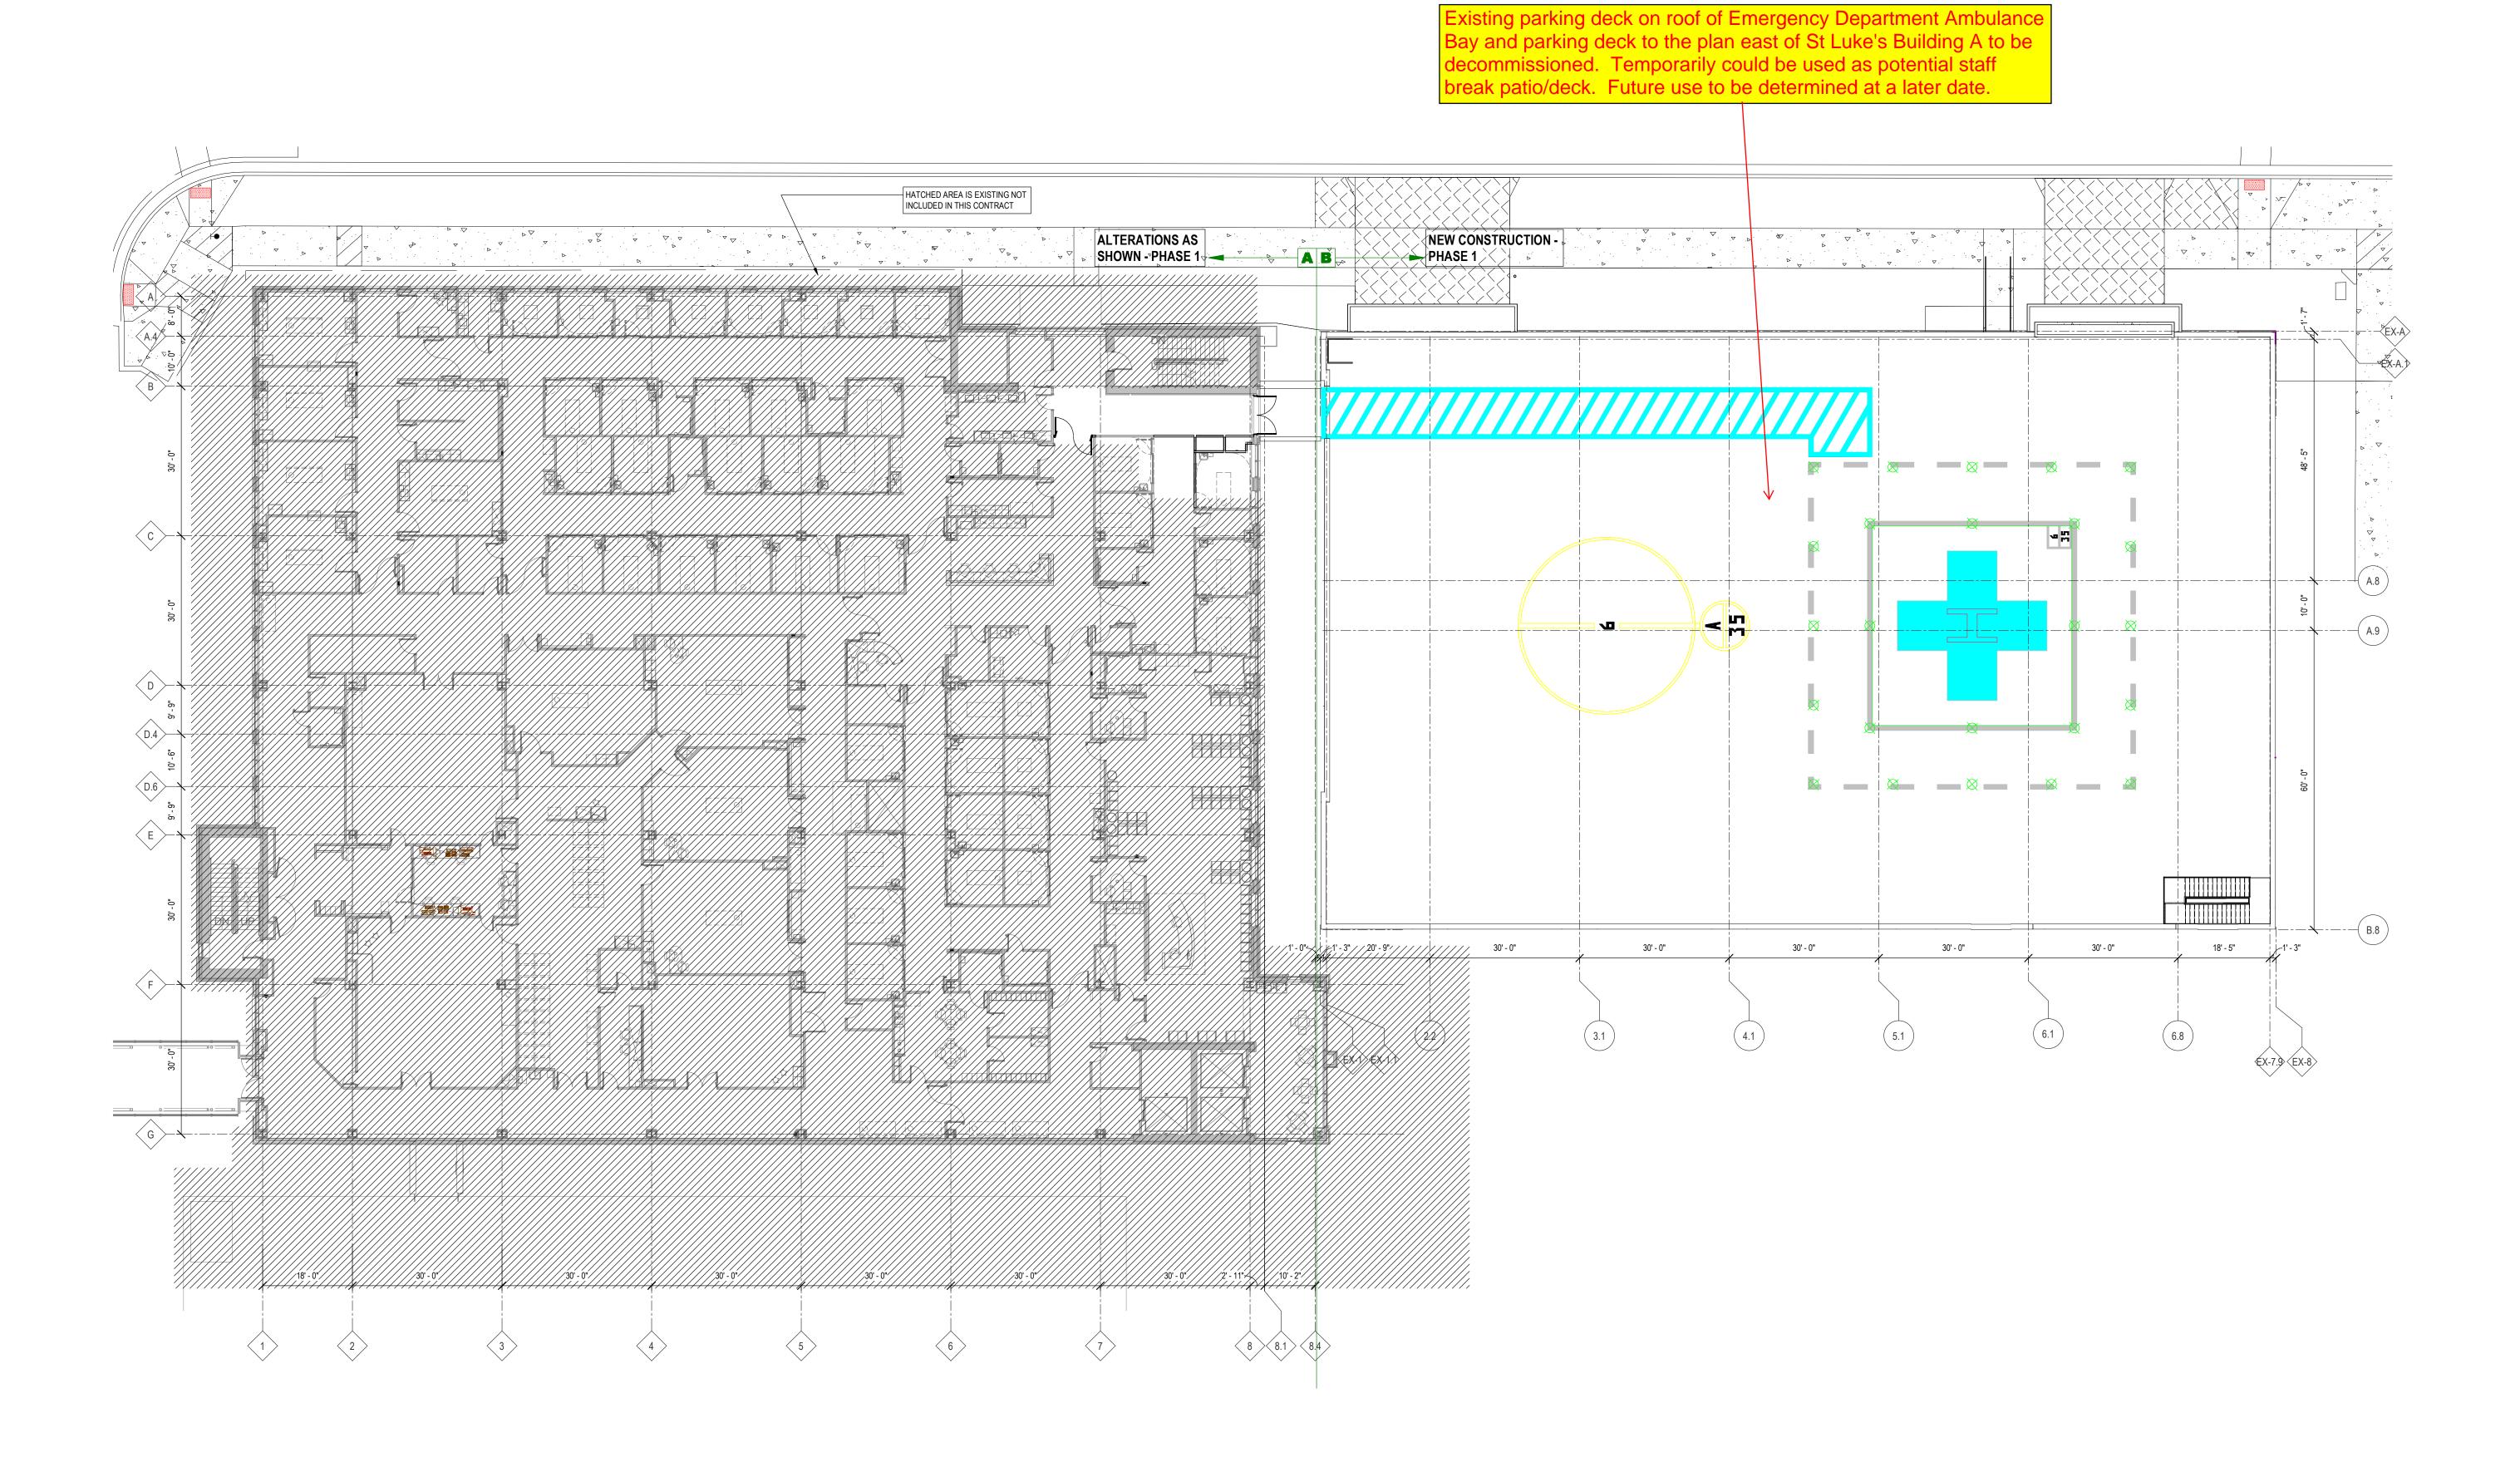

OVERALL THIRD FLOOR PLAN

SCALE: 1/16" = 1'-0"



ERDMAN

ERDMAN
One Erdman Place P.O. Box 44975
Madison, Wisconsin 53717
Phone: (608) 410-8000
FAX: (608) 410-8500

ST. LUKE'S HOSPITAL

PARKING **GARAGE WITH HELISTOP**

1012 EAST 2ND STREET DULUTH, MN 55805

Architectural Services Provided By: **ERDMAN COMPANY**

Engineering Services Provided By: **ERDMAN COMPANY**

Contractor Services Provided By: ERDMAN COMPANY **Lic. No.** IR652277

Consultant Services Provided By: **SEH**

I hereby certify that this plan, specification, or report was prepared by me or under my direct supervision and that I am a duly Licensed Architect under the laws of the state of Minnesota.

ROBERT PRATT

<u>5/14/2019</u>

License Number:

No.	Description	Date
1	PHASE 1 PERMIT SET	03/18/19
2	PHASE 1 PERMIT SET ARCH. RESUBMIT	05/14/19
3	PHASE 1 CB001	05/14/19
4	CB003 - PERMIT REVISIONS	06/07/19
5	RECORD SET	01/15/21
	4 3	4 CB003 - PERMIT REVISIONS 3 PHASE 1 CB001 2 PHASE 1 PERMIT SET ARCH. RESUBMIT

OVERALL THIRD FLOOR PLAN -PHASE 1

Drn:NBASSETT Chk:TCASEY