

411 W 1<sup>st</sup> St, Rm 208 \* Duluth, Minnesota 55802-1197 Phone: 218/730.5580 Fax: 218/723-3559

File Number	File Number PL 18-064, CUP			Contact Steven Robertson, 218-730-5295		
Type Concurrent Use Permit to Place Private Obstructions in Public Right of Way/Public Facilities (Utility Poles)		Planning Commission Date  June 12, 2018				
Deadline	Application Date  Date Extension Letter Mailed		May 8, 2018	3	·	
for Action			N/A	90 Days* (237.1	<b>63)</b> August 6, 2018	
Location of S	Location of Subject 2 Separate Sites (250 Canal Pa			West Railroad St	treet)	
Applicant	Verizon \	Vireless	Contact			
Agent	Jaymes [	D Littlejohn	Contact			
Legal Descrip	Legal Description					
Site Visit Date	е	May 30, 2018	Sign Notice Date		May 25, 2018	
Neighbor Letter Date		N/A for Concurrent Use	Number of	Letters Sent	N/A for Concurrent Use	

### **Proposal**

The applicant is proposing to "own or control two small wireless facilities in the public right-of-way, including the replacement of the existing, city owned poles and foundations to the support the new facilities. The City will continue to own the replacement poles/foundations".

The wireless facilities will not be stealthed or camouflaged; the equipment will be visibly attached to the exterior of the pole. The attachments will include 1 exterior mounted panel antenna, 2 power converters, and 2 radio units mounted approximately between at least 26 to 30 feet above the ground. The replacement poles will be 40 feet tall.

	Current Zoning	Existing Land Use	Future Land Use Map Designation
Subject	Varies	Public Right of Way	Varies
North	Varies	Public Right of Way	Varies
South	Varies	Public Right of Way	Varies
East	Varies	Public Right of Way	Varies
West	Varies	Public Right of Way	Varies

#### **Summary of Code Requirements**

UDC Section 50-37.7.C. The planning commission shall review the application, and council shall approve the application or approve it with modifications, if it determines that:

- 1) The proposed concurrent use will not harm or inconvenience the health, safety and general welfare of the city;
- 2) No portion of a public easement proposed of use is being physically occupied by the public.

### Comprehensive Plan Governing Principle and/or Policies and Current History (if applicable):

Principle #4 - Support emerging economic growth sectors. Emerging economic sectors add economic, cultural and social diversity. These include higher education, medical, value-added manufacturing, commercial outdoor recreation, historic resources interpretation, arts and music, information technology and visitor services.

The installation falls with the provisions of Minnesota Statute 237.162 and 247.1643, as amended in 2017.

This application is one of three being present to the June 12, 2018 Planning Commission. The three applications are for four separate sites (Maple Grove Road, 6<sup>th</sup> Avenue West, Canal Park Drive, and Railroad Street). In 2016 the city issued a Special Use Permit for 3 small wireless facilities on utility poles on private property owned by St Scholastica, and in 2017 the city issued a concurrent use permit for 3 small wireless facilities on utility poles owned by Minnesota Power in city right of way.

### **Review and Discussion Items**

1) Applicant is proposing to install small wireless facilities on existing city utility poles located within dedicated public rights-of-way. The two proposed locations are located in rights-of-way near Canal Park Drive and West Railroad Street.

The wireless facilities will not be stealthed or camouflaged; the equipment will be visibly attached to the exterior of the pole. The attachments will include 1 exterior mounted panel antenna, 2 power converters, and 2 radio units mounted approximately between at least 26 to 30 feet above the ground. The replacement poles will be 40 feet.

- 2) Granting a concurrent use permit would give the applicant the ability to use dedicated public rights-of-way, with conditions, while preserving other existing public uses in the same right-of-way corridors. Concurrent use permits require a public hearing and recommendation by the Planning Commission, and is approved by the City Council via ordinance. Unlike street right-of-way vacations, concurrent use permits are not recorded at the County as they are voidable permits issued by the City to applicants who are private users of public rights-of-way.
- 3) Both small wireless facilities will be similar in general configuration. Ownership of the poles will remain with the City of Duluth, with the poles in dedicated public rights-of-way. Liability, maintenance, and operation of the small wireless facilities will remain the responsibility of the applicant. In the event of an accident, such as a vehicle hitting the utility pole, the city is not responsible for restoring or replacing any of the applicant's equipment.
- 4) The existing city utility poles will be replaced with new poles, as specified and approved by the City engineer. The new poles will have a structural analysis by the manufacturer to ensure that they can support the weight of the private small cell facilities and required public infrastructure. The poles will be embedded into the ground a distance of 15 feet.
- 5) Granting the proposed concurrent use permits will not harm or inconvenience the health, safety and general welfare of the city. The area proposed for the concurrent use permit will not take away from the public's ability to use the public right-of-way. The city will own the poles and continue to use them for utility purposes (lighting).
- 6) The UDC generally requires that new wireless facilities follow a location standard: first they should be collocated on existing towers or other structures on city owned properties first, and then existing towers or other structures on other (private) property, and so forth down the location standard list. As these small wireless facilities would be located on existing infrastructure in public right of way, and as per the recent change in state statute, the city is processing these applications as concurrent use permits and not special use permits, and the UDC's use-specific standards do not apply in this specific situation.
- 7) The city has the ability to regulate land use, however, the Federal Communications Commission preempts local review on the potential environmental effects of radio frequency (RF) emissions, with the presumption that the applicant and service provider is in compliance with the Commission's RF rules.
- 8) At the time that this memo was written, no written comments from the public have been received.

#### Staff Recommendation:


Based on the above findings, Staff recommends that the Planning Commission recommend approval of the two concurrent use permits subject to the following conditions:

- 1) The project be limited to, constructed, and maintained according to construction drawings signed May 3, 2018, and included with this staff report, and as revised per the City Engineer's comments of May 29, 2018, updated June 5, 2018.
- 2) Applicant, or successor, shall remove the proposed obstructions at applicant's expense if directed to do so by the City with appropriate notice, as outlined with other conditions in the concurrent use permit ordinance to be approved by the City Council.
- 3) Any alterations to the approved plans that do not alter major elements of the plan may be approved by the Land Use Supervisor without further Planning Commission approval; however, all other changes must be approved by amending the City Council's approved ordinance.

Site Map




The City of Duluth has tried to ensure that the information contained in this map or electronic document is accurate. The City of Duluth makes no warranty or guarantee concerning the accuracy or reliability. This drawing/data is neither a legally recorded map nor a survey and is not intended to be used as one. The drawing/data is a compilation of records, information and data located in various City, County and State offices and other sources affecting the area shown and is to be used for reference purposes only. The City of Duluth shall not be liable for errors contained within this data provided or for any damages in connection with the use of this information contained within.

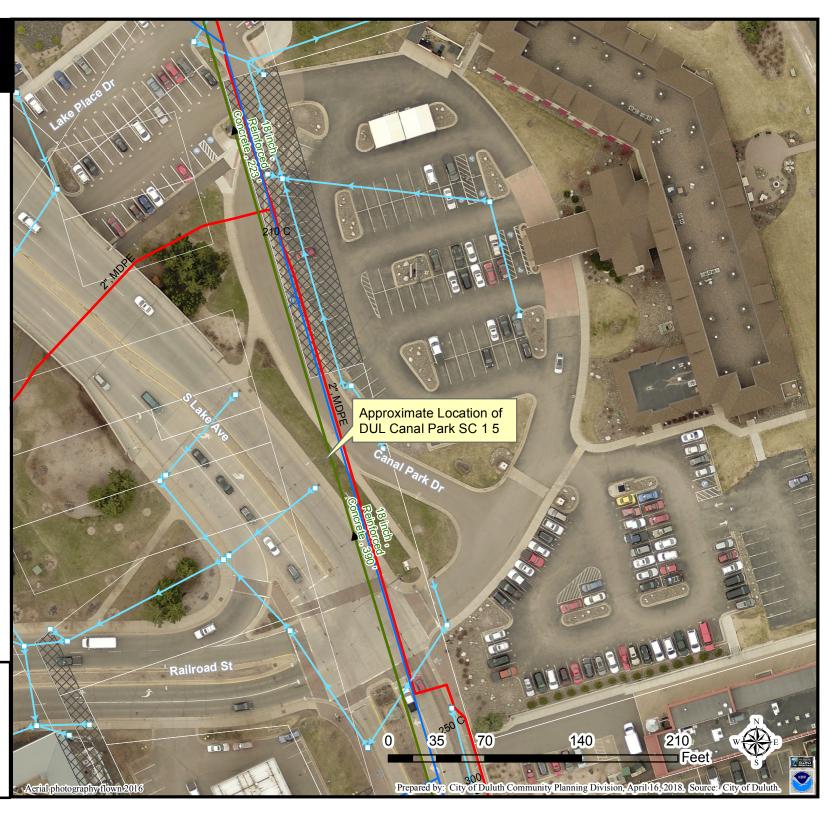

Aerial photography flown 2016

contained within.

Prepared by: City of Duluth Community Planning Division, April 16, 2018, Source: City of Duluth.

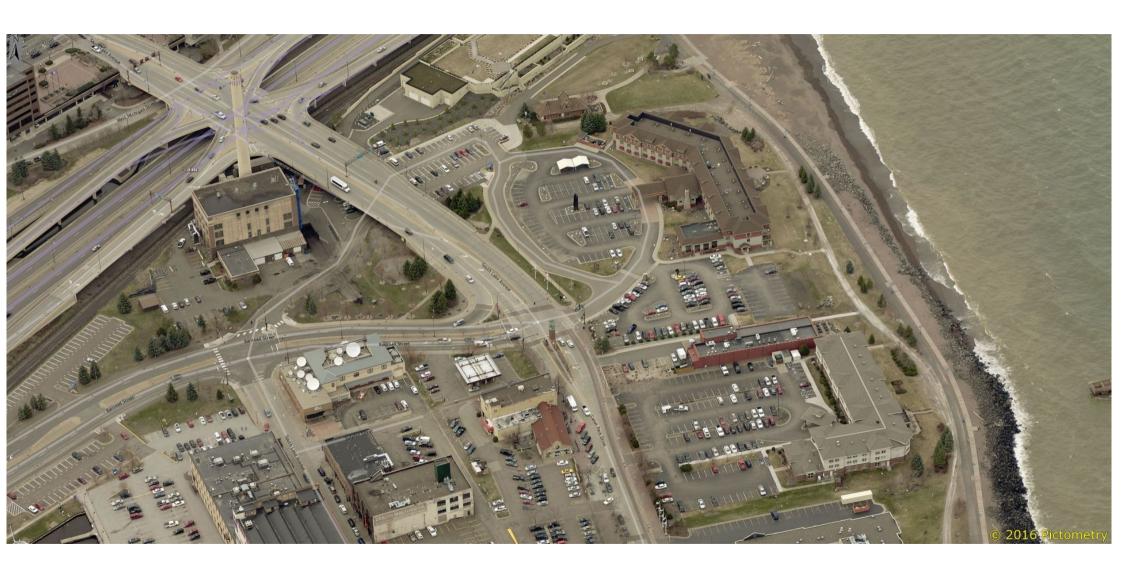

75

150

300

Prepared by: City of Duluth Community Planning Division, April 16, 2018. Source: City of Duluth

Recreation


450

Feet


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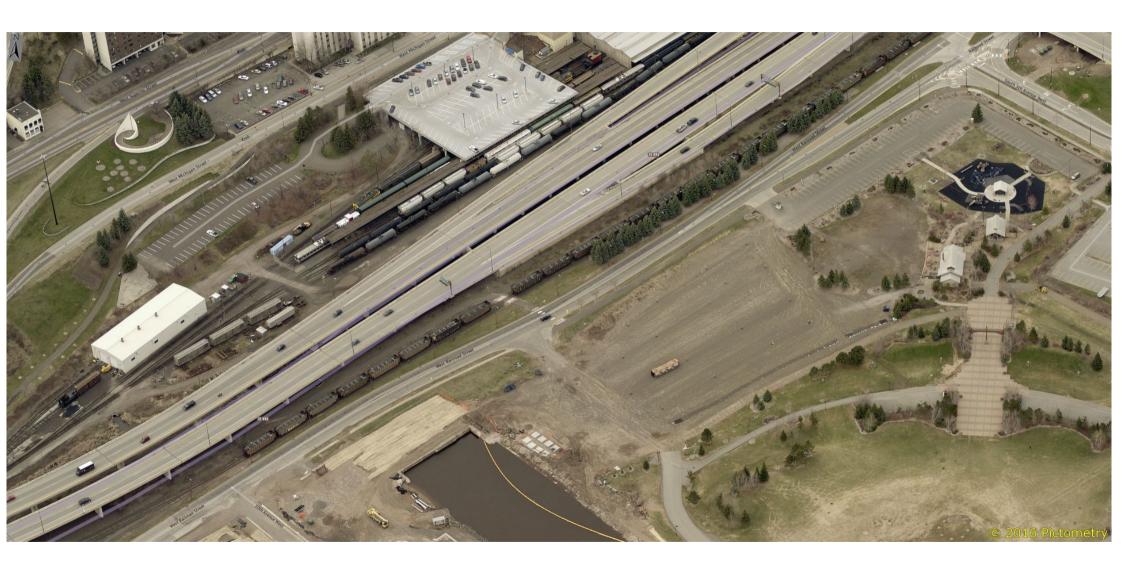
Aerial photography flown 2016

Site Map

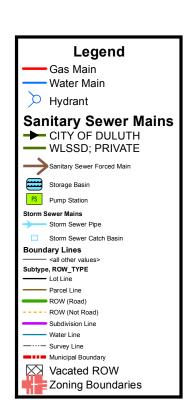

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SITE NAME:

**DUL CANAL PARK SC1 5** 

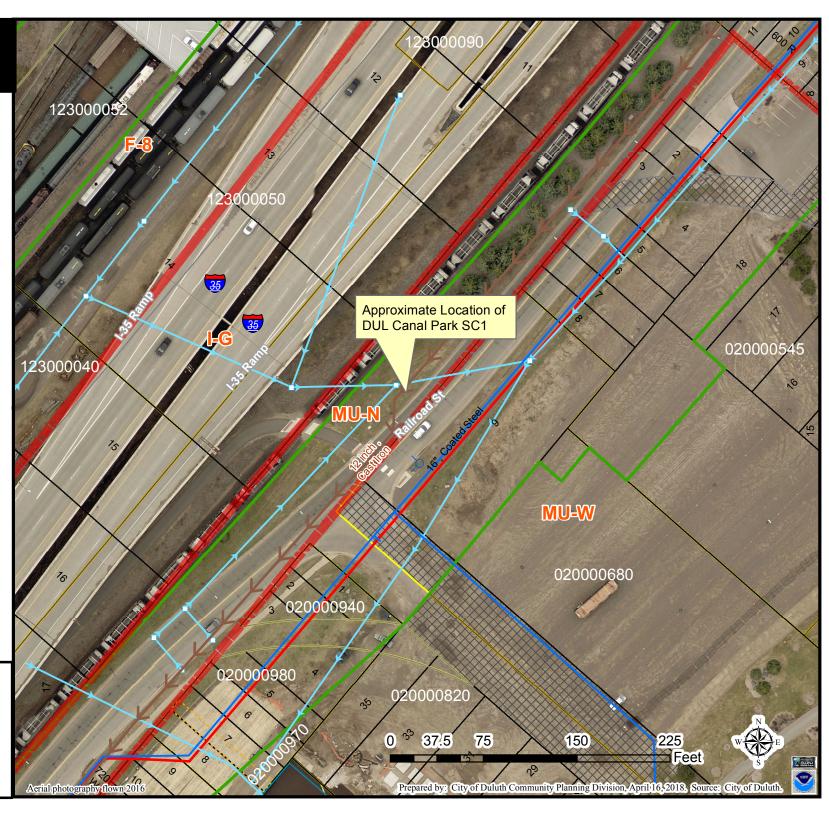SITE NUMBER:

20151281310

LOCATION CODE:

393119

SITE TYPE:

SMALL CELL

INSTALLATION TYPE: REPLACEMENT LIGHT POLE

#### SITE INFORMATION AREA MAP PROJECT DESCRIPTION/SOW SHEET INDEX INSTALL (1) REPLACEMENT STEEL LIGHT POLE AND ASSOCIATED CONCRETE APPROXIMATE ADDRESS NO: SHEET TITLE 250 CANAL PARK DRIVE DULUTH, MN 55802 INSTALLATION OF PANEL ANTENNA TITLE SHEET & PROJECT DATA SAINT LOUIS COUNTY G-002 GENERAL SPECIFICATIONS INSTALLATION OF ERICSSON RRUS AND POWER CONVERTERS G-003 GENERAL SPECIFICATIONS SITE COORDINATES: C-101 SITE PLAN INSTALLATION OF LOAD CENTER LAT: 46°-47'-07,06"N C-501 TRAFFIC CONTROL PLANS LONG: 92°-05'-43,06"W INSTALLATION OF DIPLEXERS T-201 SITE ELEVATION GROUND ELEVATION: 613.7' AMSL T-501 ANTENNA DETAILS (PER BOUNDARY SURVEY) INSTALLATION OF ELECTRIC METER, BY VERIZON T-502 EQUIPMENT DETAILS INSTALLATION OF HAND HOLE FOR FIBER AT POLE BASE, BY FIBER PROVIDER S-001 STRUCTURAL NOTES \* POLE HEIGHT: STRUCTURAL DETAILS 40'-0" T.O.C. \$-501 INSTALLATION OF CONDUIT FOR FIBER BETWEEN HAND HOLE AND POLE BASE E-101 UTILITY PLAN (APPROX. 2'-0"), TO BE TRENCHED BELOW GRADE, BY VERIZON MAXIMUM APPURTENANCE HEIGHT: E-102 UTILITY PLAN E-103 40'-7" A.G.1 INSTALLATION OF CONDUIT FOR FIBER IN ROW, TO BE TRENCHED BELOW GRADE GROUNDING PLAN BY PROVIDER E-501 UTILITY DETAILS E-502 GROUNDING DETAILS INSTALLATION OF NEW ELECTRIC SERVICE CONDUIT AND CONDUCTORS FROM POLE BASE TO POWER SOURCE, BY VERIZON REMOVE EXISTING FOUNDATION, BY VERIZON REMOVE EXISTING LIGHT POLE AND DELIVER TO CITY OF DULUTH, BY VERIZON INSTALLATION OF GROUND SYSTEM AROUND POLE FOUNDATION ALL OTHER CONSTRUCTION RELATED ACTIVITIES TO BE COMPLETED BY OTHERS APPLICABLE CODES **LOCATION MAP** COMPLETED BY OTHERS \*\* REVIEWED AND APPROVED BY STRUCTURAL ENGINEER

ALL WORK SHALL COMPLY WITH THE FOLLOWING APPLICABLE CODES:

- 2012 INTERNATIONAL BUILDING CODE
- 2014 NATIONAL ELECTRIC CODE - TIA/EIA-222-G OR LATEST EDITION

IN THE EVENT OF CONFLICT, THE MOST RESTRICTIVE CODE SHALL PREVAIL

#### **LOCATION SCAN**





## PROJECT DIRECTORY

LESSEE:
VERIZON WIRELESS
10801 BUSH LAKE RD
BLOOMINGTON, MN 55438
CONTACT; RICK WENTA
PHONE: 952.946.4690

PHONE: 608,644,1449

PHONE: 952,831,1043

ENGINEERING COMPANY;
EDGE CONSULTING ENGINEERS, INC.
2101 HIGHWAY 13 W
BURNSVILLE, MN 55337
CONTACT: OTTO DINGFELDER III, P.E.

SITE ACQUISITION:

JACOBS ENGINEERING GROUP, INC.
2727 PATTON ROAD
ROSEVILLE, MN 55113
CONTACT: AMY DRESCH

#### LESSOR:

CITY OF DULUTH 411 W 1ST ST DULUTH, MN 55802 PHONE: 218.730.5000

### RE ENGINEER:

VERIZON WIRELESS 10801 BUSH LAKE RD BLOOMINGTON, MN 55438 CONTACT: MICHAEL KOCH

# WORK OR BE RESPONSIBLE FOR THE SAME. ENGINEER OF RECORD

11"x17" PLOT WILL BE HALF SCALE

UNLESS OTHERWISE NOTED

CONTRACTOR SHALL VERIFY ALL PLANS AND EXISTING

DIMENSIONS/CONDITIONS ON SITE. IMMEDIATELY NOTIFY

ENGINEER OF ANY DISCREPANCIES PRIOR TO PERFORMING ANY

EDGE CONSULTING ENGINEERS, INC. CONTACT: OTTO DINGFELDER III (PE # 49720 (MN)) PHONE: 608.644.1449

#### STRUCTURAL REVIEW

FOUNDATION DESIGN: EDGE CONSULTING ENGINEERS PROJECT #: 16592 DATE: 10/17/2017 Pole Design: Valmont Drawing #: MN379742P1 Date: 10/12/2017

CONTRACTOR TO REVIEW STRUCTURAL REPORT IN ITS ENTIRETY.
ANY DISCREPANCIES OR DISAGREEMENTS BETWEEN THE REPORT
AND THESE PLANS SHOULD BE RESOLVED PRIOR TO CONSTRUCTION.



JACOBS

Jacobs Engineering Group, Inc.
2727 Potton Road



20nsuiting Engineers, 2101 Highway 13 W Burnsville, MN 55337 608,644,1449 voice 608,644,1549 fax www.edgeconsult.com

PROJECT NO:	20151281310
LOCATION CODE:	393119
EDGE PROJECT NO:	16592
CHECKED BY:	OGD

_	REV.	DATE	DESCRIPTION	INT.
	A	08/29/2017	PRELIM SMALL CELL DWGS	MITS
	0	09/13/2017	FINAL DRAWINGS	MTS
_	1	10/27/2017	FINAL DRAWINGS	DGS
_	2	04/25/2018	FINAL DRAWINGS	MWH
_	3	04/26/2018	FINAL DRAWINGS	мwн
-	4	05/03/2018	FINAL DRAWINGS	MWH
_	5	06/05/2018	FINAL DRAWINGS	RJK
_				
_				
-				
		1		



OR REPORT WAS PREPARED BY ME OR UNDER MY DIRECT SUPERVISION AND THAT I AM A DULY LICENSED PROFESSIONAL ENGINEER UNDER THE LAWS OF THE STATE OF MINNESOTA.

> DUL CANAL PARK SC1 5 DULUTH, MINNESOTA REPLACEMENT LIGHT POLE SMALL CELL DRAWINGS

> > SHEET TITLE

TITLE SHEET & PROJECT DATA

SHEET NUMBER

G-001



A ) AERIAL OVERVIEW



SITE OVERVIEW [LOOKING SOUTHEAST]

В



SITE OVERVIEW [LOOKING NORTHWEST]

#### NOTES:

CONTRACTOR TO COMPLETE A UTILITY LOCATE PRIOR TO COMMENCING ALL CONSTRUCTION ACTIVITIES.

CONTRACTOR TO RE-SEED ANY AND ALL DISTURBED GRASS AREAS. REFER TO THE LOCAL MUNICIPALITY FOR SEEDING SPECIFICATIONS.

#### POWER AND FIBER ROUTING NOTE:

THE PROPOSED POWER AND FIBER ROUTES ARE PRELIMINARY, AND WILL BE CONFIRMED WITH THE LANDLORD AND FIBER PROVIDER PRIOR TO CONSTRUCTION. IF THE GENERAL CONTRACTOR NOTICES ANY DISCREPANCIES BETWEEN THESE PLANS AND THE ACTUAL SOURCES OF POWER AND RBER. THE VERIZON CONSTRUCTION ENGINEER AND PROJECT ENGINEER ARE TO BE NOTIFIED PRIOR TO COMMENCING WORK.


#### QUALIFICATION OF WORKERS NOTE:

ANY WORK ON EQUIPMENT WILL NEED TO BE DIRECTLY SUPERVISED OR PERFORMED BY A CONTRACTOR EMPLOYEE WHO IS MNDOT SISNAL AND LIGHTING CERTIFIED:

MINNESOTA 2016 STANDARD SPECIFICATIONS 2545 LIGHTING SYSTEMS 2545, I DESCRIPTION B QUALIFICATION OF WORKERS

PARSONS ELECTRIC CONTACT: TORY PHONE: 218-591-1621 HUNT ELECTRIC CONTACT: JEFF PHONE: 218-628-3323

PERSUANT TO DIRECTION FROM DULUTH CITY ENGINEER; VERIZON ELECTRICAL SERVICE WILL BE ROUTED USING SEPARATE CONDUIT OUTSIDE OF CITY'S EXISTING CONDUIT, #10 AWG CONDUCTORS ARE NOT REQUIRED.

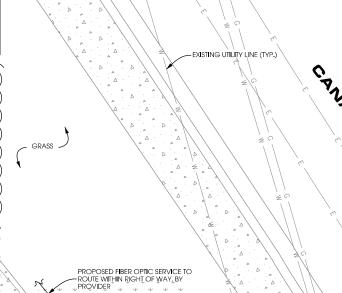

PROPOSED CONDUIT FOR FIBER OPTIC

PROPOSED CONDUIT FOR FIBER OPTIC

SERVICE BETWEEN POLE BASE AND HAND
HOLE, BY VERIZON

REPLACEMENT LIGHT POLE

PROPOSED SINGLE METER, BY VERIZON

PROPOSED ELECTRICAL CONDUIT TO ROUTE FROM POLE BASE TO POWER SOURCE, BY VERIZON; SEE SHEET E-101 FOR DETAILS

EXISTING UTILITY LINE (TYP.)

EXISTING UTILITY LINE (TYP.)

EXISTING POLE (TVP.)

GRASS

EXISTING SIDEWALK

SCALE:

11" x 17" - 1" = 10' 22" x 34" - 1" = 5' verizon verizon

## **JACOBS**

Jacobs Engineering Group, Inc 2727 Patton Road RosevIIIe, Minnesota 55113 www.jacobs.com



2101 Highway 13 W Burnsville, MN 55337 608.644.1449 volce 608.644.1549 fax www.edgeconsulf.com

16592

PROJECT NO: 20151281310

LOCATION CODE: 393119

CHECKED BY: OGD

EDGE PROJECT NO:

REV.	DATE	DESCRIPTION	INT.
А	08/29/2017	PRELIM SMALL CELL DWGS	MTS
0	09/13/2017	FINAL DRAWINGS	MTS
1	10/27/2017	FINAL DRAWINGS	DGS
2	04/25/2018	FINAL DRAWINGS	MWH
3	04/26/2018	FINAL DRAWINGS	MWH
4	05/03/2018	FINAL DRAWINGS	MWH
5	06/05/2018	FINAL DRAWINGS	RJK

APPROVED SEE SHEET GOOT

I HEREBY CERTIFY THAT THIS PLAN, SPECFICATION, OR REPORT WAS PREPARED BY ME OR UNDER MY DIRECT SUPERVISION AND THAT I AM A DULY LICENSED PROFESSIONAL ENGINEER UNDER THE LAWS OF THE STATE OF MINNESOTA.

> DUL CANAL PARK SC1 5 DULUTH, MINNESOTA REPLACEMENT LIGHT POLE SMALL CELL DRAWINGS


> > SHEET TITLE

SITE PLAN

SHEET NUMBER


C-101

© EDGE CONSULTING ENGINEERS, INC.

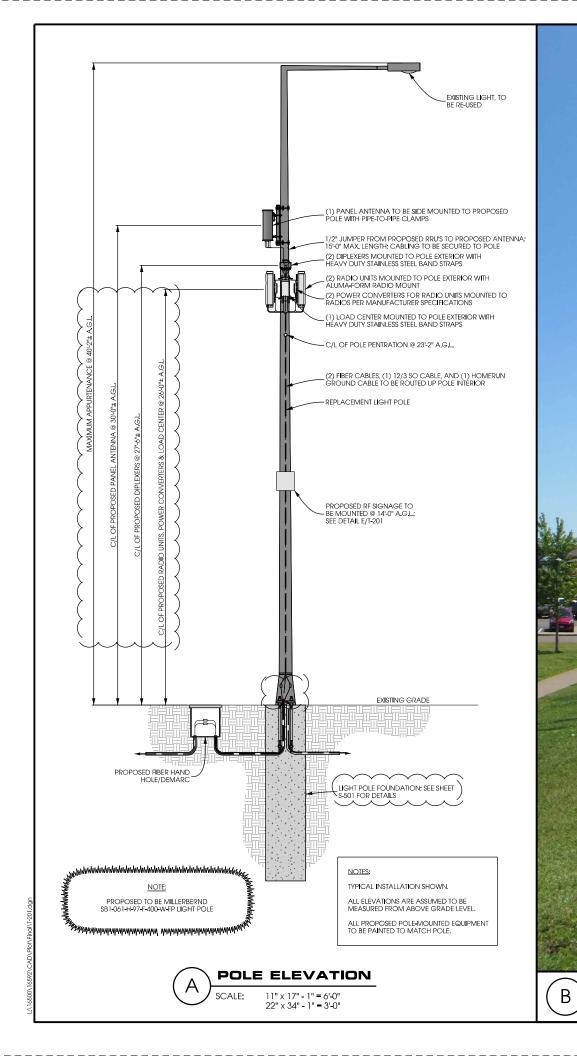





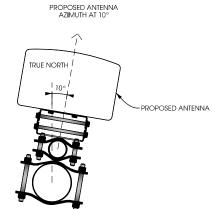

# **ANTENNA ORIENTATION**

ANTENNAS						
QUANTITY MAKE MODEL CENTERLINE TIP HEIGHT AZIMUTH						
1	COMMSCOPE	HBXX-6513DS-A2M	30' AGL	31'-6" AGL	10°	

EQUIPMENT					
QUANTITY TYPE MAKE MODEL					
1	RRU	ERICSSON	RRUS32 B66		
1	RRU	ERICSSON	RRUS32 B2		
2	DIPLEXER	COMMSCOPE	CBC 1923T-43 10 E1 1F13PO6		

CABLING					
QUANTITY TYPE MAKE MODEL					
6	COAX	COMMSCOPE	LFD4-50		







SITE ELEVATION











**JACOBS** Jacobs Engineering Group, Inc 2727 Patton Road Roseville, Minnesota 55113 www.jacobs.com



2101 Highway 13 W Burnsville, MN 55337 608.644.1449 volce 608.644.1549 fax www.edgeconsult.com

20151281310 PROJECT NO: LOCATION CODE: 393119 EDGE PROJECT NO: 16592

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	5	06/05/2018	FINAL DRAWINGS	RJK

APPROVED SEESHEET GOO! hknorth ste steel styl

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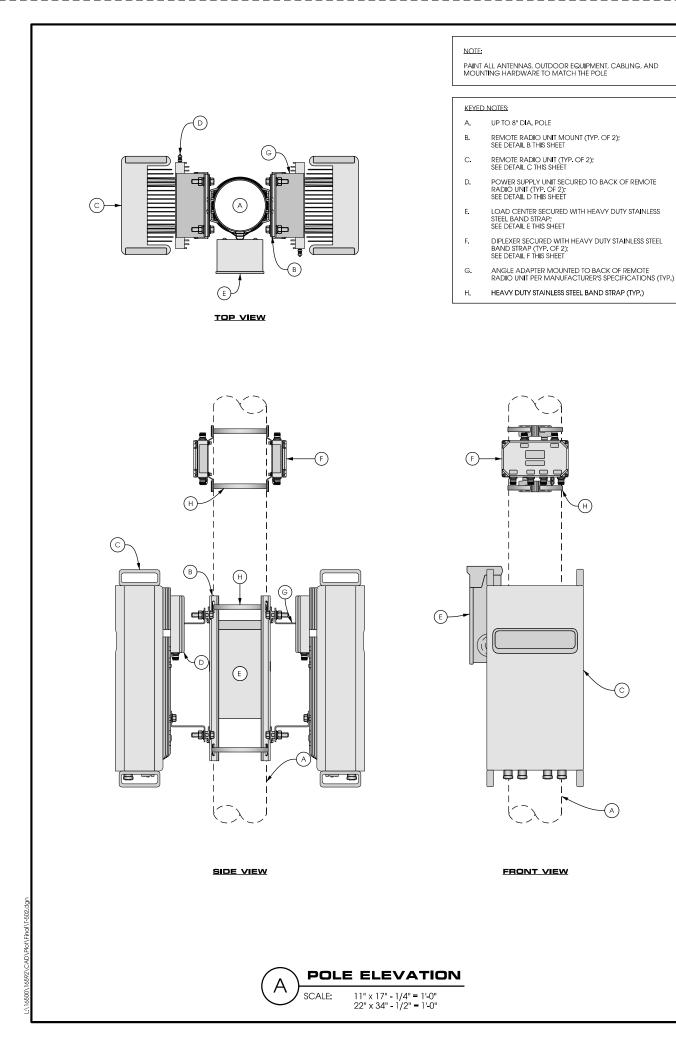
DUL CANAL PARK SC1 5 DULUTH, MINNESOTA REPLACEMENT LIGHT POLE SMALL CELL DRAWINGS


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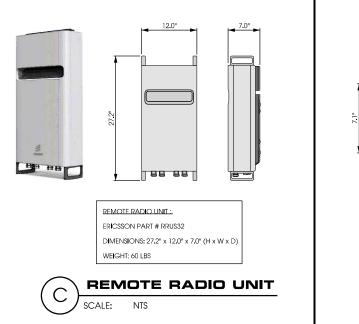
SITE ELEVATION

SHEET NUMBER


T-201





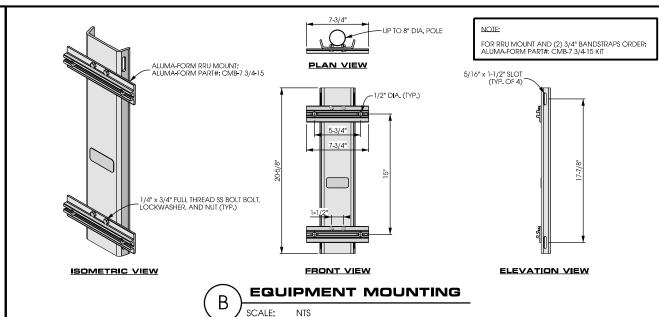

WEIGHT: 6.8 LBS.

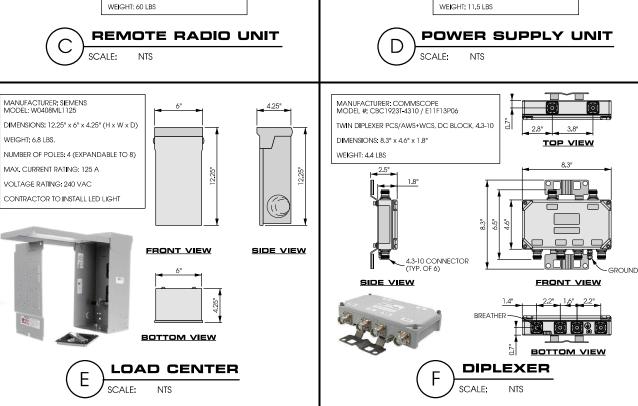

POWER SUPPY UNIT:

ERICSSON PART #: PSU AC-08

DIMENSIONS: 10.8" x 7.1" x 1.9" (H x W x D)







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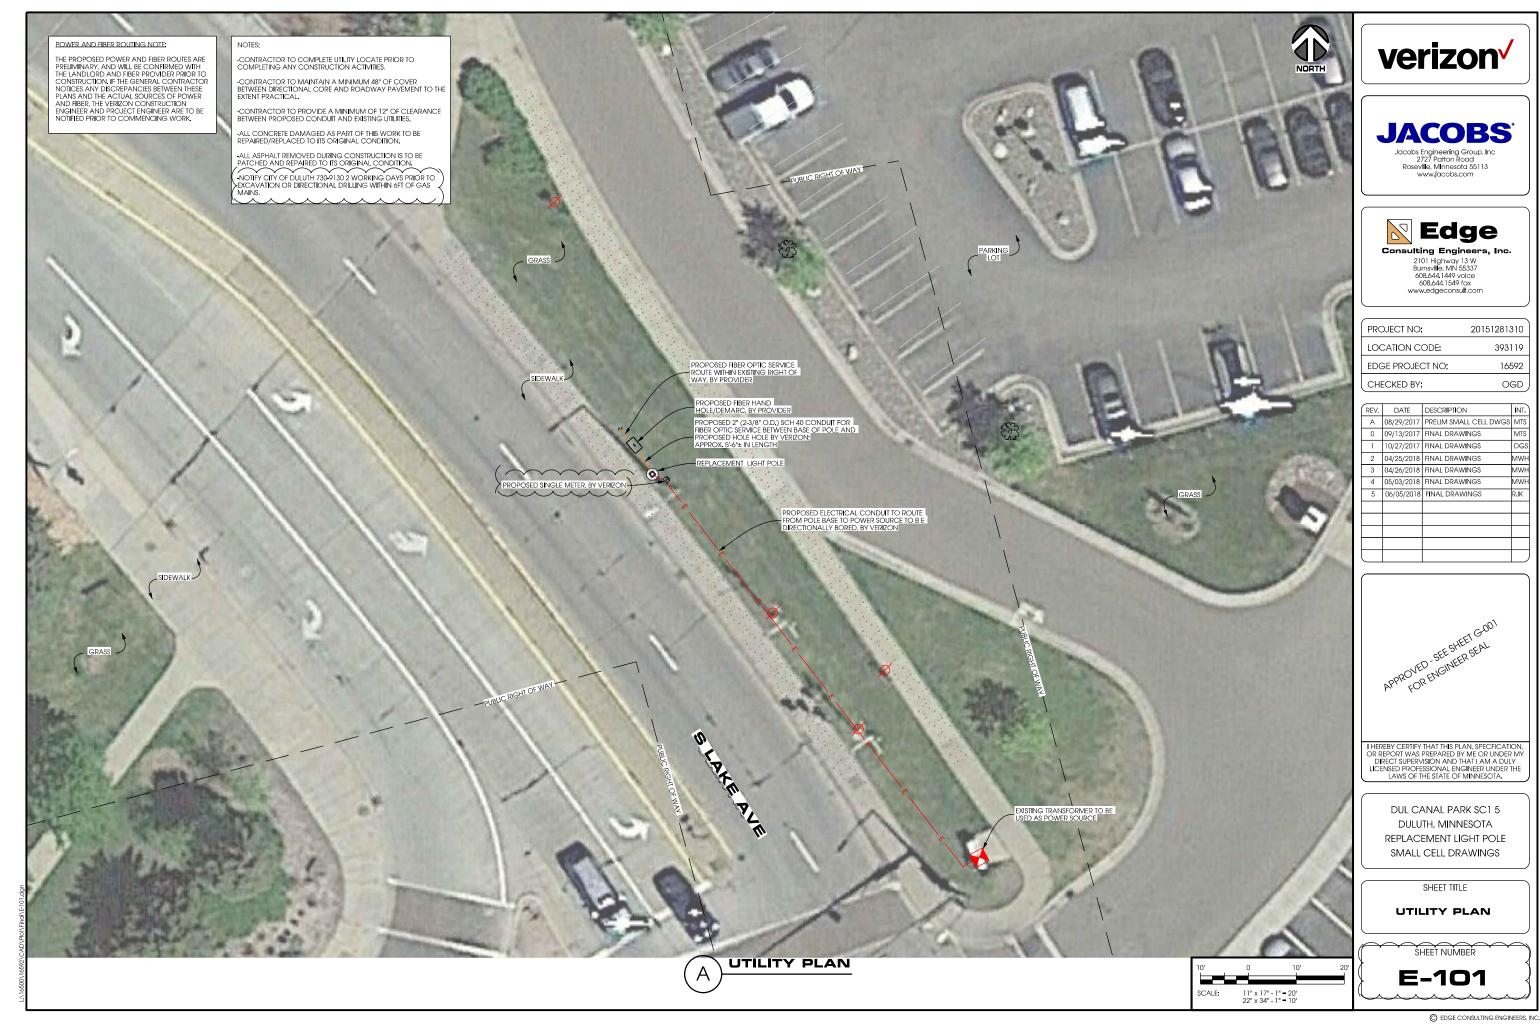
DUL CANAL PARK SC1 5 DULUTH, MINNESOTA REPLACEMENT LIGHT POLE SMALL CELL DRAWINGS

SHEET TITLE

**EQUIPMENT** DETAILS

SHEET NUMBER







SITE NAME:

**DUL CANAL PARK SC1** 

SITE NUMBER:

20130998150

**LOCATION CODE:** 

2440128

SITE TYPE:

SMALL CELL

LESSOR:

CITY OF DULUTH

DULUTH, MN 55802

PHONE: 218.730.5000

**VERIZON WIRELESS** 

10801 BUSH LAKE RD BLOOMINGTON, MN 55438

CONTACT: MICHAEL KOCH

411 W 1ST ST

RF.ENGINEER:

INSTALLATION TYPE: REPLACEMENT LIGHT POLE

#### SITE INFORMATION AREA MAP PROJECT DESCRIPTION/SOW SHEET INDEX CHECKED BY: INSTALL (1) REPLACEMENT STEEL LIGHT POLE AND ASSOCIATED CONCRETE APPROXIMATE ADDRESS: SHEET TITLE NO: 688 W RAILROAD ST **DULUTH, MN 55802** INSTALLATION OF PANEL ANTENNA G-001 TITLE SHEET & PROJECT DATA SAINT LOUIS COUNTY G-002 GENERAL SPECIFICATIONS INSTALLATION OF ERICSSON RRUS AND POWER CONVERTERS G-003 GENERAL SPECIFICATIONS SITE COORDINATES: C-101 SITE PLAN INSTALLATION OF LOAD CENTER LAT: 46°-46'-44,62"N C-501 TRAFFIC CONTROL PLANS LONG: 92°-06'-15,92"W INSTALLATION OF DIPLEXERS T-201 SITE ELEVATION GROUND ELEVATION: 608,1' AMSL T-501 ANTENNA DETAILS (PER 1A CERTIFICATE) INSTALLATION OF ELECTRIC METER, BY VERIZON EQUIPMENT DETAILS T-502 INSTALLATION OF HAND HOLE FOR FIBER AT POLE BASE, BY FIBER PROVIDER STRUCTURAL NOTES POLE HEIGHT: 40'-0" T.O.C. S-501 STRUCTURAL DETAILS \* INSTALLATION OF CONDUIT FOR FIBER BETWEEN HAND HOLE AND POLE BASE E-101 UTILITY PLAN (APPROX. 2'-0"). TO BE TRENCHED BELOW GRADE BY VERIZON. MAXIMUM APPURTENANCE HEIGHT: E-102 40'-7" A.G.L. INSTALLATION OF CONDUIT FOR FIBER IN ROW, TO BE TRENCHED BELOW GRADE, F-103 GROUNDING PLAN BY PROVIDER E-501 UTILITY DETAILS GROUNDING DETAILS E-502 INSTALLATION OF NEW ELECTRIC SERVICE CONDUIT AND CONDUCTORS FROM POLE BASE TO POWER SOURCE, BY VERIZON REMOVE EXISTING FOUNDATION, BY VERIZON REMOVE EXISTING LIGHT POLE AND DELIVER TO CITY OF DULUTH, BY VERIZON INSTALLATION OF GROUND SYSTEM AROUND POLE FOUNDATION ALL OTHER CONSTRUCTION RELATED ACTIVITIES TO BE COMPLETED BY OTHERS **APPLICABLE CODES** LOCATION MAP COMPLETED BY OTHERS \*\* REVIEWED AND APPROVED BY STRUCTURAL ENGINEER ALL WORK SHALL COMPLY WITH THE FOLLOWING APPLICABLE CODES: 11"x17" PLOT WILL BE HALF SCALE PROJECT DIRECTORY UNLESS OTHERWISE NOTED - 2012 INTERNATIONAL BUILDING CODE - 2014 NATIONAL ELECTRIC CODE - TIA/EIA-222-G OR LATEST EDITION CONTRACTOR SHALL VERIFY ALL PLANS AND EXISTING

## IN THE EVENT OF CONFLICT, THE MOST RESTRICTIVE CODE SHALL PREVAIL

## LOCATION SCAN





# LESSEE: VERIZON WIRELESS 10801 BUSH LAKE RD BLOOMINGTON, MN 556

10801 BUSH LAKE RD BLOOMINGTON, MN 55438 CONTACT: RICK WENTA PHONE: 952,946,4690

## ENGINEERING COMPANY: EDGE CONSULTING ENGINEERS, INC.

2101 HIGHWAY 13 W BURNSVILLE, MN 55337 CONTACT: OTTO DINGFELDER III, P.E. PHONE: 608.644.1449

### SITE ACQUISITION:

JACOBS ENGINEERING GROUP, INC. 2727 PATION ROAD ROSEVILLE, MN 55113 CONTACT: AMY DRESCH PHONE: 952.831,1043 CONTRACTOR SHALL VERIFY ALL PLANS AND EXISTING DIMENSIONS/CONDITIONS ON SITE. IMMEDIATELY NOTIFY ENGINEER OF ANY DISCREPANCIES PRIOR TO PERFORMING ANY WORK OR BE RESPONSIBLE FOR THE SAME.

#### **ENGINEER OF RECORD**

EDGE CONSULTING ENGINEERS, INC. CONTACT; OTTO DINGFELDER III (PE # 49720 (MN)) PHONE; 608,644.1449

#### STRUCTURAL REVIEW

FOUNDATION DESIGN: EDGE CONSULTING ENGINEERS PROJECT #: 16591 DATE: 10/17/2017 POLE DESIGN: VALMONT DRAWING #: MN379742P1 DATE: 10/12/2017

CONTRACTOR TO REVIEW STRUCTURAL REPORT IN ITS ENTIRETY.
ANY DISCREPANCIES OR DISAGREEMENTS BETWEEN THE REPORT
AND THESE PLANS SHOULD BE RESOLVED PRIOR TO CONSTRUCTION.



## **JACOBS**

Jacobs Engineering Group, Ir 2727 Patton Road Roseville, Minnesota 55113



2101 Highway 13 W Burnsville, MN 55337 608,644,1449 voice 608,644,1549 fax www.edgeconsult.com


 PROJECT NO:
 20131998150

 LOCATION CODE:
 2440128

 EDGE PROJECT NO:
 16591

OGD

| REV. DATE | DESCRIPTION | INT. | A | 08/29/2017 | PRELIM SMALL CELL DWGS | KJM | 0 | 09/13/2017 | FINAL DRAWINGS | MTS | 1 | 10/27/2017 | FINAL DRAWINGS | DGS | 2 | 04/25/2018 | FINAL DRAWINGS | MWH | 3 | 04/26/2018 | FINAL DRAWINGS | MWH | 4 | 05/03/2018 | FINAL DRAWINGS | MWH | 5 | 06/05/2018 | FINAL DRAWINGS | RJK | | |

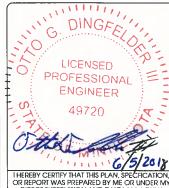

THEREBY CERTIFY THAT THIS PLAN, SPECFICATION, OR REPORT WAS PREPARED BY ME OR UNDER MY DIRECT SUPERVISION AND THAT I AM A DULY LICENSED PROFESSIONAL ENGINEER UNDER THE LAWS OF THE STATE OF MINNESOTA.


DUL CANAL PARK SC1 DULUTH, MN REPLACEMENT LIGHT POLE SMALL CELL DRAWINGS

SHEET TITLE

TITLE SHEET & PROJECT DATA

SHEET NUMBER

G-001

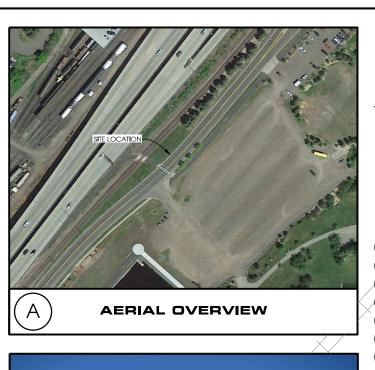





[LOOKING NORTH]



SITE OVERVIEW [LOOKING SOUTHWEST]

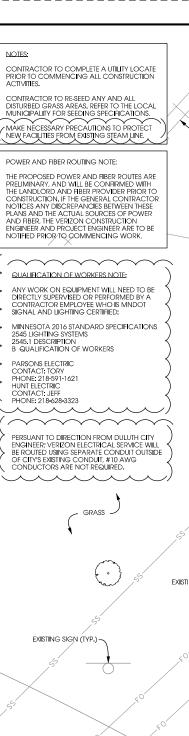

PARSONS ELECTRIC CONTACT: TORY
PHONE: 218-591-1621
HUNT ELECTRIC
CONTACT: JEFF
PHONE: 218-628-3323

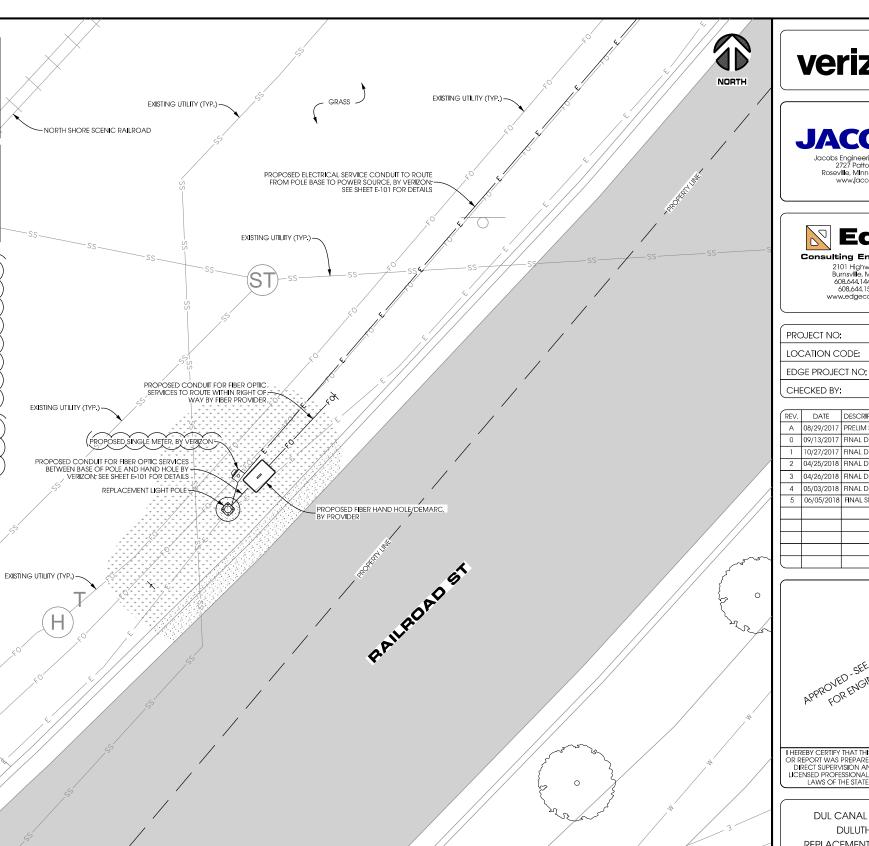



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Jacobs Engineering Group, Inc 2727 Patton Road Roseville, Minnesota 55113 www.jacobs.com

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PROJECT NO: 20131998150 LOCATION CODE: 2440128

CHECKED BY: OGD

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REV. DATE A 08/29/2017 PRELIM SMALL CELL DWGS KJM 0 09/13/2017 FINAL DRAWINGS 1 10/27/2017 FINAL DRAWINGS 2 04/25/2018 FINAL DRAWINGS MWH 3 04/26/2018 FINAL DRAWINGS 4 05/03/2018 FINAL DRAWINGS 5 06/05/2018 FINAL SMALL CELL DWGS RJK

> APPROVED SEESHEET GOOT rryvey - ste steel stal

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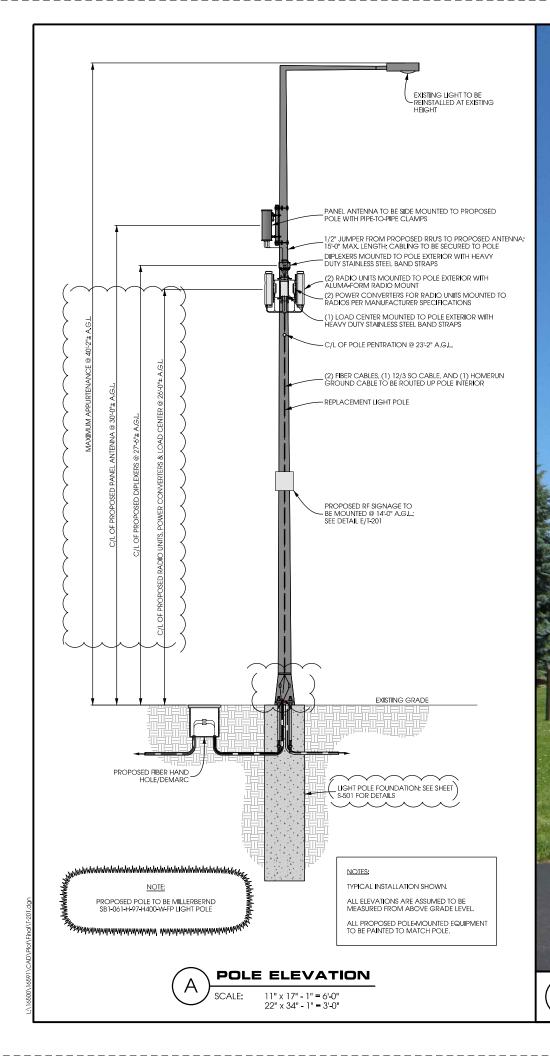
SHEET TITLE

SITE PLAN

SHEET NUMBER

C-101


11" x 17" - 1" = 10' 22" x 34" - 1" = 5'



В

SITE ELEVATION



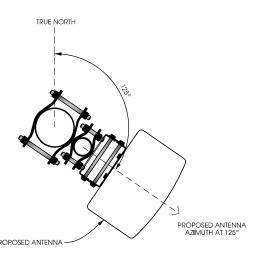

# C ANTENNA ORIENTATION SCALE: NTS

ANTENNAS							
QUANTITY MAKE MODEL CENTERLINE TIP HEIGHT AZIMUTH							
1	COMMSCOPE	HBXX-6513DS-A2M	30' AGL	31'-6" AGL	125°		

EQUIPMENT					
QUANTITY	TYPE	MAKE	MODEL		
1	RRU	ERICSSON	RRUS32 B66		
1	RRU	ERICSSON	RRUS32 B2		
2	DIPLEXER	COMMSCOPE	CBC 1923T-43 10 E1 1F13PO6		

CABLING					
QUANTITY	TYPE	MAKE	MODEL		
10	COAX	COMMSCOPE	LFD4-50		







o frequency fields beyond this point EXCEED the FCC Occupational sure Limit.

all posted signs and sits guidelines. Vertron Wireless at 1-800-264-6620 fit to working beyond this point.







io frequency fields beyond this It MAY EXCESS the FCC General ulation Exposure Limit. Ly all posted signs and site guidelines. Varizee Wireless at 1-800-264-6820 DR to working beyond this point.





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www.jacobs.com



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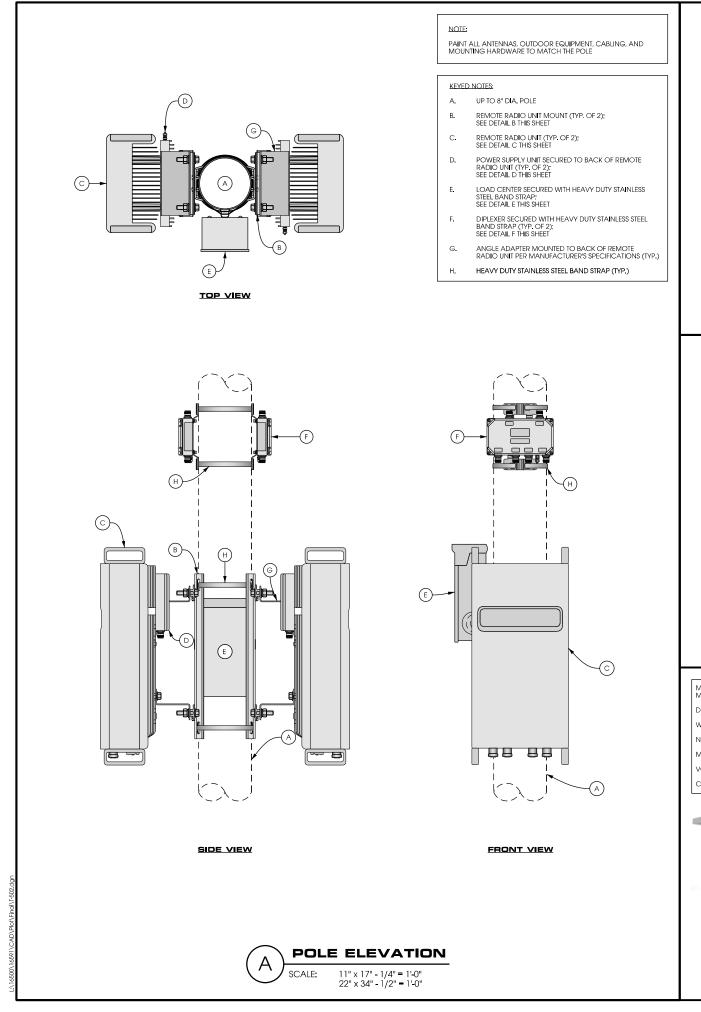
> DUL CANAL PARK SC1 DULUTH, MN REPLACEMENT LIGHT POLE SMALL CELL DRAWINGS


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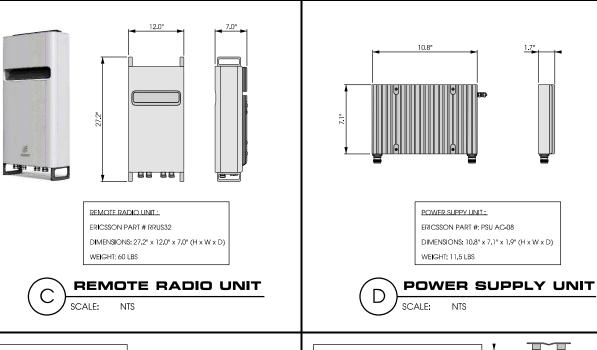
SITE ELEVATION


SHEET NUMBER

T-201





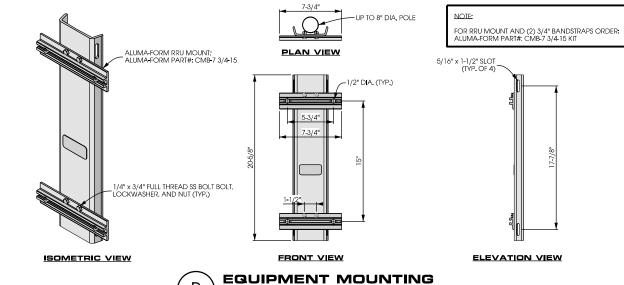

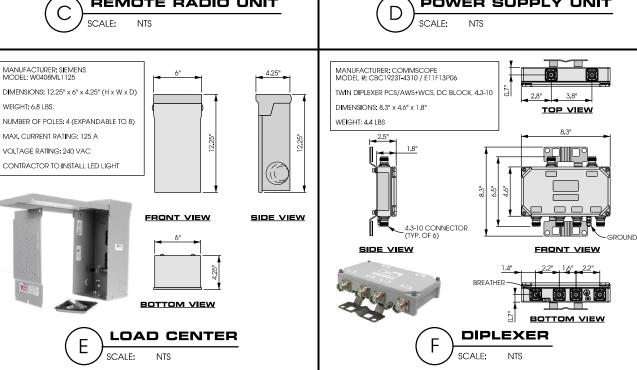



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2727 Patton Road
Roseville, Minnesota 55113
www.jacobs.com



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SHEET TITLE

EQUIPMENT DETAILS

SHEET NUMBER

T-502

