

CITY OF DULUTH

Community Planning Division

411 W 1st St, Rm 208 * Duluth, Minnesota 55802-1197 Phone: 218/730.5580 Fax: 218/723-3559

File Number	PL 18-12	7, CUP	Contact	Steven Robertson	, 218-730-5295
Туре	Private C	ent Use Permit to Place Three Obstructions in the Public Right Public Facilities	Planning (Commission Date	October 9, 2018
Deadline	Applica	tion Date	September	10, 2018	
for Action	Date Extension Letter Mailed		N/A	90 Days* (237.16	33) January 8, 2019
Location of S	Subject	Three Sites Near E Superior St	reet and Nor	th 60 th Avenue Eas	t
Applicant	Verizon \	Wireless	Contact		
Agent	Amy Dre	sch	Contact		
Legal Description On-file					
Site Visit Date		September 26, 2018	Sign Notic	ce Date	September 24, 2018
Neighbor Letter Date		N/A for Concurrent Use	Number o	f Letters Sent	I/A for Concurrent Use

Proposal. The applicant is proposing to install three small cell installations "...two are co-locations on Minnesota Power wood utility power poles in the right of way near the intersection of E Superior Street and North 60th Ave E and the third is a proposed collocation on a Minnesota Power wood light pole located near the intersection of E Superior Street and Occidental Blvd...the purpose of these proposed small wireless facility installations is to address the data capacity and overage into the area as well as addressing capacity issues...". The project will replace the existing wooden poles with new poles, which will be between 34 and 38 feet tall.

Recommended Action: Recommend to the City Council (Ordinance) to Approve with Conditions.

	Current Zoning	Existing Land Use	Future Land Use Map Designation
Subject	F-2, P-1	Commercial	Neighborhood Mixed Use
North	R-1, P1	Residential/Recreation	Traditional Neighborhood/Preservation
South	R-1	Residential	Traditional Neighborhood
East	R-1	Residential	Low-density Neighborhood
West	R-1	Residential	Traditional Neighborhood

Summary of Code Requirements

UDC Section 50-37.7.C. The planning commission shall review the application, and council shall approve the application or approve it with modifications, if it determines that:

- 1) The proposed concurrent use will not harm or inconvenience the health, safety and general welfare of the city;
- 2) No portion of a public easement proposed of use is being physically occupied by the public.

Comprehensive Plan Governing Principle and/or Policies and Current History (if applicable):

Principle #4 - Support emerging economic growth sectors. Emerging economic sectors add economic, cultural and social diversity. These include higher education, medical, value-added manufacturing, commercial outdoor recreation, historic resources interpretation, arts and music, information technology and visitor services.

The installation falls with the provisions of Minnesota Statute 237.162 and 247.1643, as amended in 2017.

Future Land Use: A transitional use between more intensive commercial uses and purely residential neighborhoods. Includes conversions of houses to office or live-work spaces. May include limited commercial-only space oriented to neighborhood or specialty retail markets.

Review and Discussion Items

1) The applicant is proposing three small wireless facilities on existing Minnesota Power poles. The project will replace the existing wooden poles with new poles, between 34 and 38 feet tall

2) Granting a concurrent use permit would give the applicant the ability to use dedicated public rights-of-way, with conditions, while preserving other existing public uses in the same right-of-way corridors. Concurrent use permits require a public hearing and recommendation by the Planning Commission, and is approved by the City Council via ordinance. Unlike street right-of-way vacations, concurrent use permits are not recorded at the County as they are voidable permits issued by the City to applicants who are private users of public rights-of-way.

3) Ownership of the poles will remain with Minnesota Power.

4) The replacement wooden poles will have a structure analysis by the manufacturer to ensure that they can support the weight of the private small cell facilities and required public infrastructure.

5) Granting the proposed concurrent use permit will not harm or inconvenience the health, safety and general welfare of the city. The area proposed for the concurrent use permit will not take away from the public's ability to use the public right-of-way.

6) The UDC generally requires that new wireless facilities follow a location standard: first they should be collocated on existing towers or other structures on city owned properties first, and then existing towers or other structures on other (private) property, and so forth down the location standard list. As these small wireless facilities would be located on existing infrastructure in public right of way, and as per the recent change in state statute, the city is processing these applications as concurrent use permits and not special use permits, and the UDC's use-specific standards do not apply in this specific situation.

7) The city has the ability to regulate land use; however, the Federal Communications Commission preempts local review on the potential environmental effects of radio frequency (RF) emissions, with the presumption that the applicant and service provider is in compliance with the Commission's RF rules. The applicant has submitted FCC categorical exclusion documentation for the sites with the initial application.


8) At the time that this memo was written, no written comments from the public have been received. City Engineering was still reviewing the exhibits at the time this staff report was written, and will likely have some requests for changes related to some of the technical aspects of the installations in the right of way.

Staff Recommendation:

Based on the above findings, Staff recommends that the Planning Commission recommend approval of the two concurrent use permits subject to the following conditions:

- 1) The project be limited to, constructed, and maintained according to construction drawings submitted and included with this staff report
- 2) Applicant, or his or her successors, shall remove the proposed obstructions at applicant's expense if directed to do so by the City with appropriate notice.

3) Any alterations to the approved plans that do not alter major elements of the plan may be approved by the Land Use Supervisor without further Planning Commission approval; however, all other changes must be approved by amending the City Council's approved ordinance.

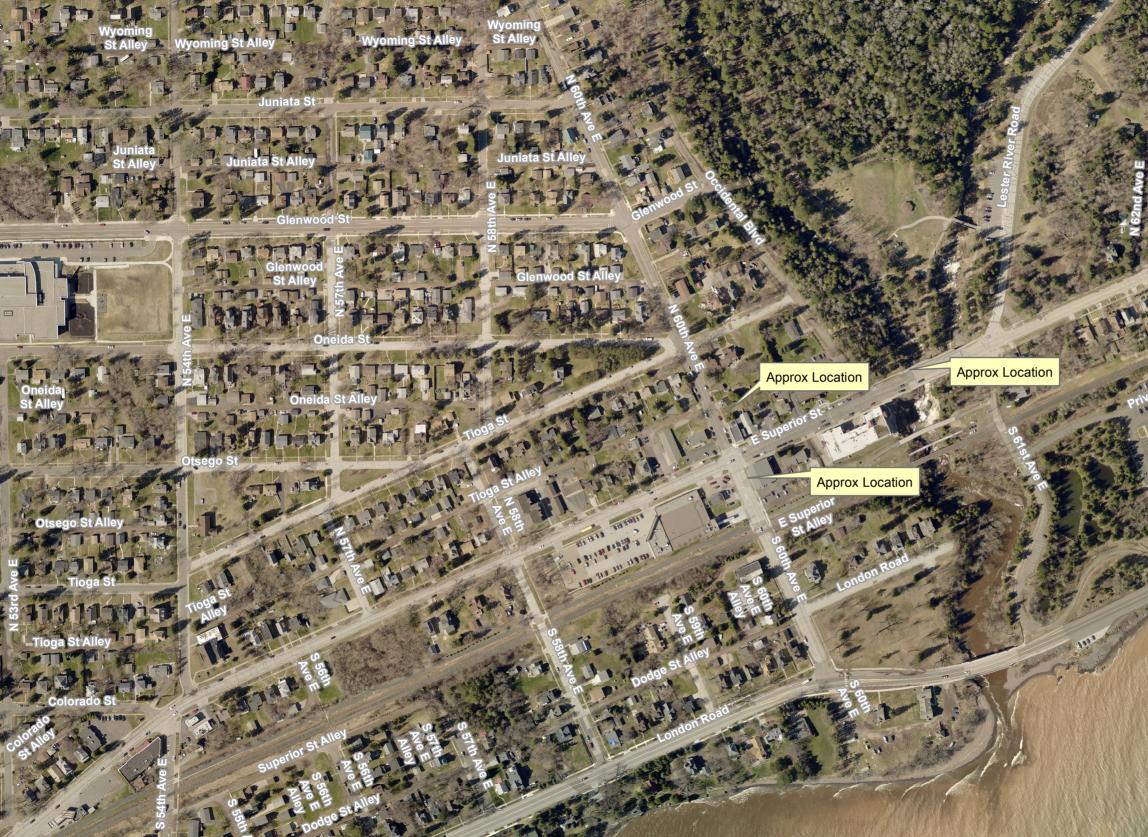

- 198






PL 18-127 CUP

Legend Zoning Boundaries Future Land Use - Plus **Future Land Use** Preservation Recreation Rural Residential Low-density Neighborhood Traditional Neighborhood Urban Residential Neighborhood Commercial Neighborhood Mixed Use General Mixed Use Central Business Secondary Central Business Primary Auto Oriented Commercial Large-scale Commercial Business Park Tourism/Entertainment District Medical District Institutional **Commercial Waterfront** Industrial Waterfront Light Industrial **General Industrial** Transportation and Utilities

The City of Duluth has tried to ensure that the information contained in this map or electronic document is accurate. The City of Duluth makes no warranty or guarantee concerning the accuracy or reliability. This drawing/data is neither a legally recorded map nor a survey and is not intended to be used as one. The drawing/data is a compilation of records, information and data located in various City, County and State offices and other sources affecting the area shown and is to be used for reference purposes only. The City of Duluth shall not be liable for errors contained within this data provided or for any damages in connection with the use of this information contained within.

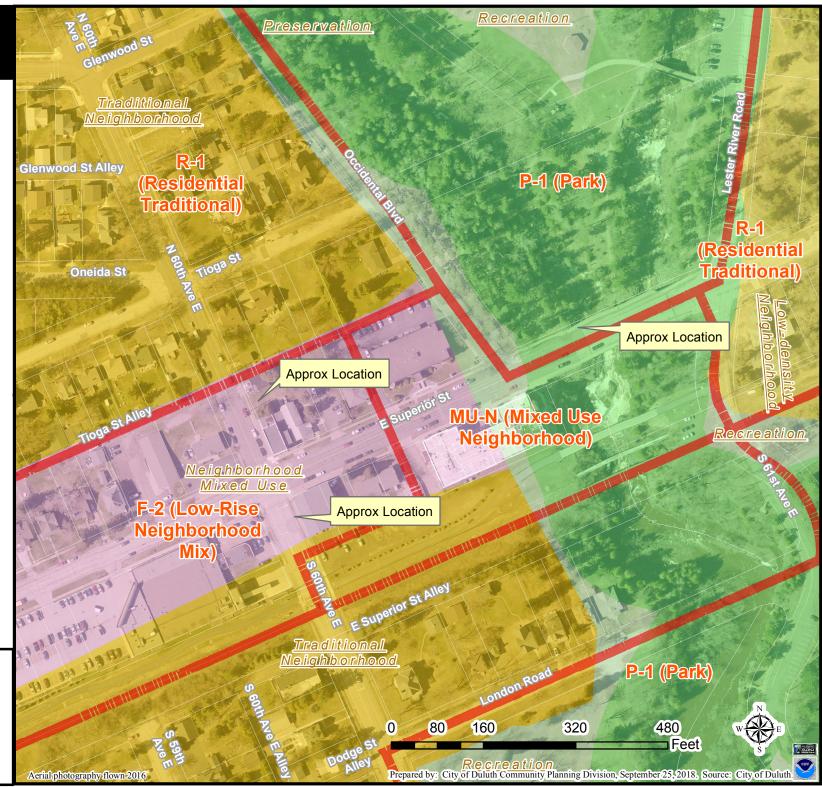





The City of Duluth has tried to ensure that the information contained in this map or electronic document is accurate. The City of Duluth makes no warranty or guarantee concerning the accuracy or reliability. This drawing/data is neither a legally recorded map nor a survey and is not intended to be used as one. The drawing/data is a compilation of records, information and data located in various City, County and State offices and other sources affecting the area shown and is to be used for reference purposes only. The City of Duluth shall not be liable for errors contained within this data provided or for any damages in connection with the use of this information contained within.



SITE NAME: **DUL SUPER ONE SC1** 20171735330 SITE NUMBER: verizon LOCATION CODE: 484029 SITE TYPE: SMALL CELL

INSTALLATION TYPE: REPLACEMENT LIGHT POLE

SITE INFORMATION	REPLACEMENT POLE	PROJECT DESCRIPT	rion/sow		SHEET INDEX	
APPROXIMATE ADDRESS: 6002 E, SUPERIOR		WORK PRODUCT	INSTALLED BY	NO:	SHEET TITLE	
DULUTH, MN 55804		REPLACEMENT WOOD LIGHT POLE	MN POWER	G-001	TITLE SHEET & PROJECT DATA	
ST, LOUIS COUNTY		OVERHEAD ELECTRIC SERVICE BETWEEN POLE BASE AND POWER	FIBER PROVIDER	G-002	GENERAL SPECIFICATIONS	
		SOURCE		G-003	GENERAL SPECIFICATIONS	
ITE COORDINATES: LAT; 46°-50'-18.00''N		FIBER CONDUIT, BETWEEN HAND HOLE AND POLE BASE, TO BE	FIBER PROVIDER	N/A	SURVEY	
LONG: 92°-00'-32.82"W		TRENCHED/DIRECTIONALLY BORED BELOW GRADE		C-101	SITE PLAN	
GROUND ELEVATION: 659.7' AMSL		FIBER CONDUIT, WITHIN RIGHT OF WAY, TO BE TRENCHED/DIRECTIONALLY BORED BELOW GRADE	FIBER PROVIDER	T-201	SITE ELEVATION	
(PER 1A CERTIFICATE)				T-501	ANTENNA DETAILS	
	OTOT DE LE CONTRACTOR	FIBER HAND HOLE AT POLE BASE	VERIZON	T-502 E-101	EQUIPMENT DETAILS	
	ISINP +	DIPLEXERS LOAD CENTER	VERIZON	E-101	GROUNDING PLAN	
		ELECTRICAL METER	VERIZON	E-501	UTILITY DETAILS	
		ERICSSON RRUS AND POWER CONVERTERS	VERIZON	E-502	GROUNDING DETAILS	
		PANEL ANTENNA	VERIZON			
			· · · · · · · · · · · · · · · · · · ·			
APPLICABLE CODES	LOCATION MAP					
APPLICABLE CODES	LUCATION MAP				MPLETED BY OTHERS	
WORK SHALL COMPLY WITH THE FOLLOWING ARRUCARLE CODES	A the finite trained O	∮↓		** REVIEWED AND APPROVED BY STRUCTURAL ENGINEER		
L WORK SHALL COMPLY WITH THE FOLLOWING APPLICABLE CODES:	NCRTH	PROJECT DIRECTORY			11"x17" PLOT WILL BE HALF SCAL UNLESS OTHERWISE NOTED	
2014 NATIONAL ELECTRIC CODE TIA/EIA-222-G OR LATEST EDITION				CONT	CONTRACTOR SHALL VERIFY ALL PLANS AND EXISTING	
		LESSEE: LESS			SIONS/CONDITIONS ON SITE, IMMEDIATELY NO	
HE EVENT OF CONFLICT, THE MOST RESTRICTIVE CODE SHALL PREVAIL		VERIZON WIRELESS MINNESOTA POWER COMPANY 10801 BUSH LAKE RD 30 W SUPERIOR ST			ENGINEER OF ANY DISCREPANCIES PRIOR TO PERFORMING WORK OR BE RESPONSIBLE FOR THE SAME.	
	Divide 2 Traps	10801 BUSH LAKE RD 30 BLOOMINGTON, MN 55438 DU	LUTH, MN 55802			
LOCATION SCAN	Synellation	CONTACT: AMANDA TURNER PH	ONE: 218.722.2625	ENIC	GINEER OF RECORD	
	North Shore Veternary Heapthal Tangles A Sation	PHONE; 952.946.4706				
■諜■	Carego Sa Carego Sa	ENGINEERING COMPANY: EDGE CONSULTING ENGINEERS, INC. 2101 HIGHWAY 13 W BURNSVILLE, MN 55337 BLOOMINGTON, MN 55438	CONT	EDGE CONSULTING ENGINEERS, INC. CONTACT: OTTO DINGFELDER III (PE # 49720 (MN)) PHONE: 608,644,1449		
27502265	Auntry Contor Guper One Foods & E American Faceby N Sibit Are E		NTACT; MICHAEL KOCH	STF	UCTURAL REVIE	
	haunat Varia L. Carror S. L. Carrov S. L. Ca	SITE ACQUISITION: JACOBS ENGINEERING GROUP, INC. 2727 PATTON ROAD ROSEVILLE, MN 55113 CONTACT: AMY DRESCH		to B Pro.	ANALYSIS COMPLETED BY: E DETERMINED JECT #: 18069 R TO REVIEW STRUCTURAL REPORT IN ITS ENTIR	
	ri Sao	PHONE: 952.831.1043		ANY DISCREF	ANCIES OR DISAGREEMENTS BETWEEN THE RE LANS SHOULD BE RESOLVED PRIOR TO CONST	

|--|



JACOBS

Jacobs Engineering Group, Inc 2727 Patton Road Roseville, Minnesota 55113 www.jacobs.com



2101 Highway 13 W Burnsylle, MN 55337

608.644.1449 voice 608.644.1549 fax www.edgeconsult.com

PROJECT NO:

20171735330 484029

> 18069 OGD

LOCATION CODE:

EDGE PROJECT NO:

CHECKED BY:


REV.	DATE	DESCRIPTION	INT
Α	05/03/2018	PRELIM SMALL CELL DWGS	ZRS
В	05/15/2018	PRELIM SMALL CELL DWGS	M₩ŀ
С	05/17/2018	PRELIM SMALL CELL DWGS	KJM
0	08/16/2018	FINAL SMALL CELL DWGS	M₩⊦
\square			




DULUTH, MINNESOTA REPLACEMENT LIGHT POLE SMALL CELL DRAWINGS



G-001

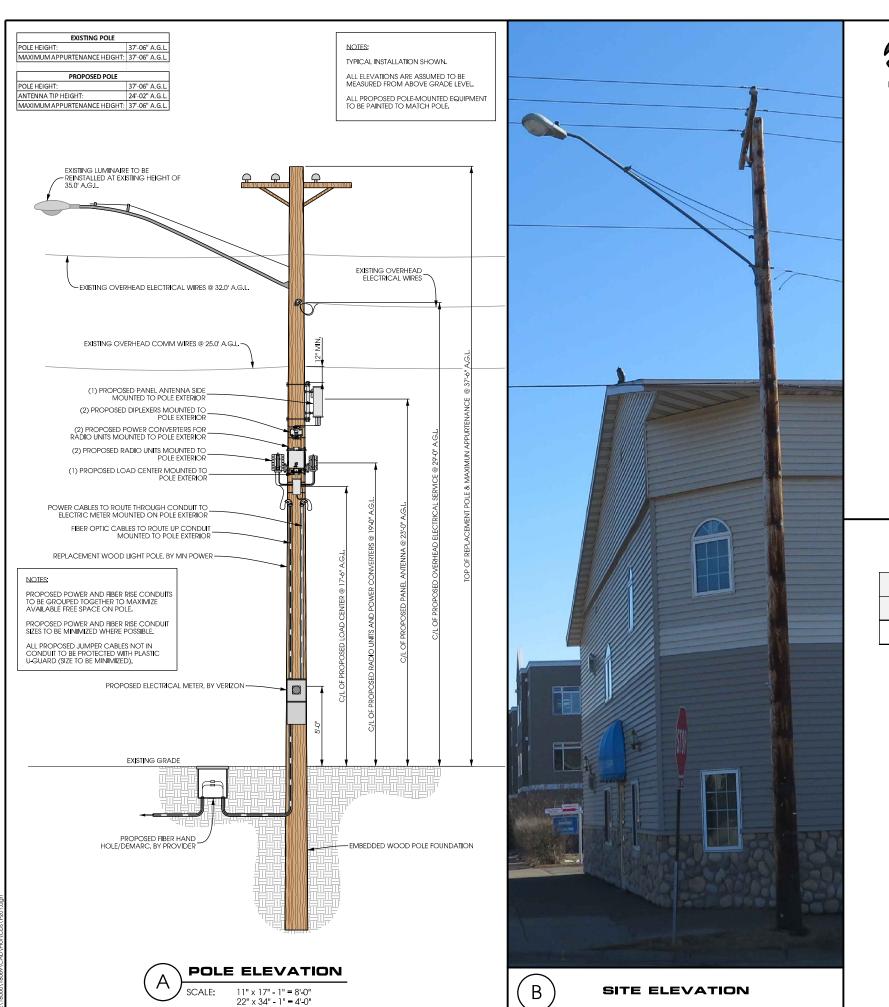

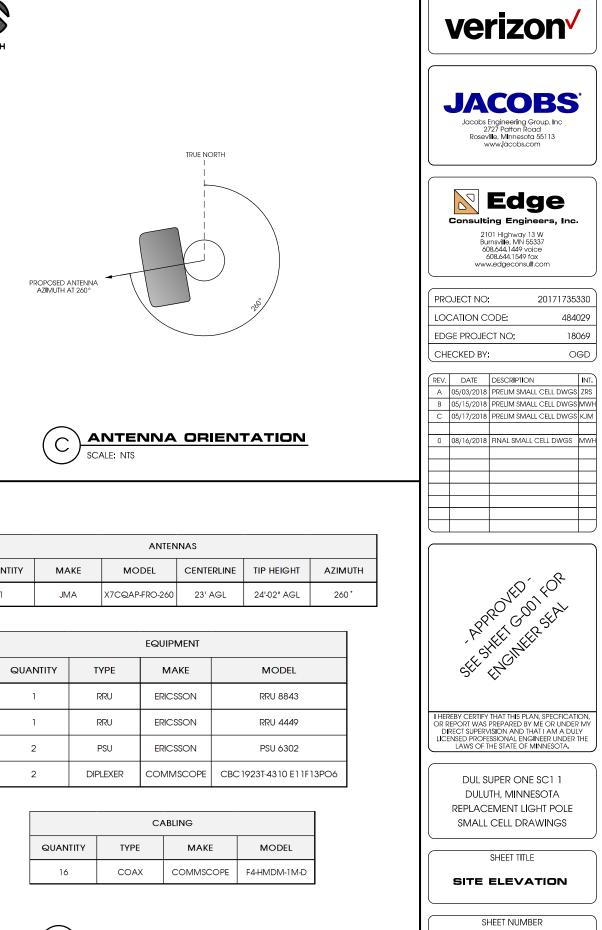


			-
ANTENN		INAS	
QUANTITY	MAKE	MODEL	CEN
1	JMA	X7CQAP-FRO-260	23

	EQUIPMENT
TYPE	MAKE
RRU	ERICSSON
RRU	ERICSSON
PSU	ERICSSON
DIPLEXER	COMMSCOPE
	RRU RRU PSU


	CA	BLING
QUANTITY	TYPE	MA
16	COAX	COMM



T-201

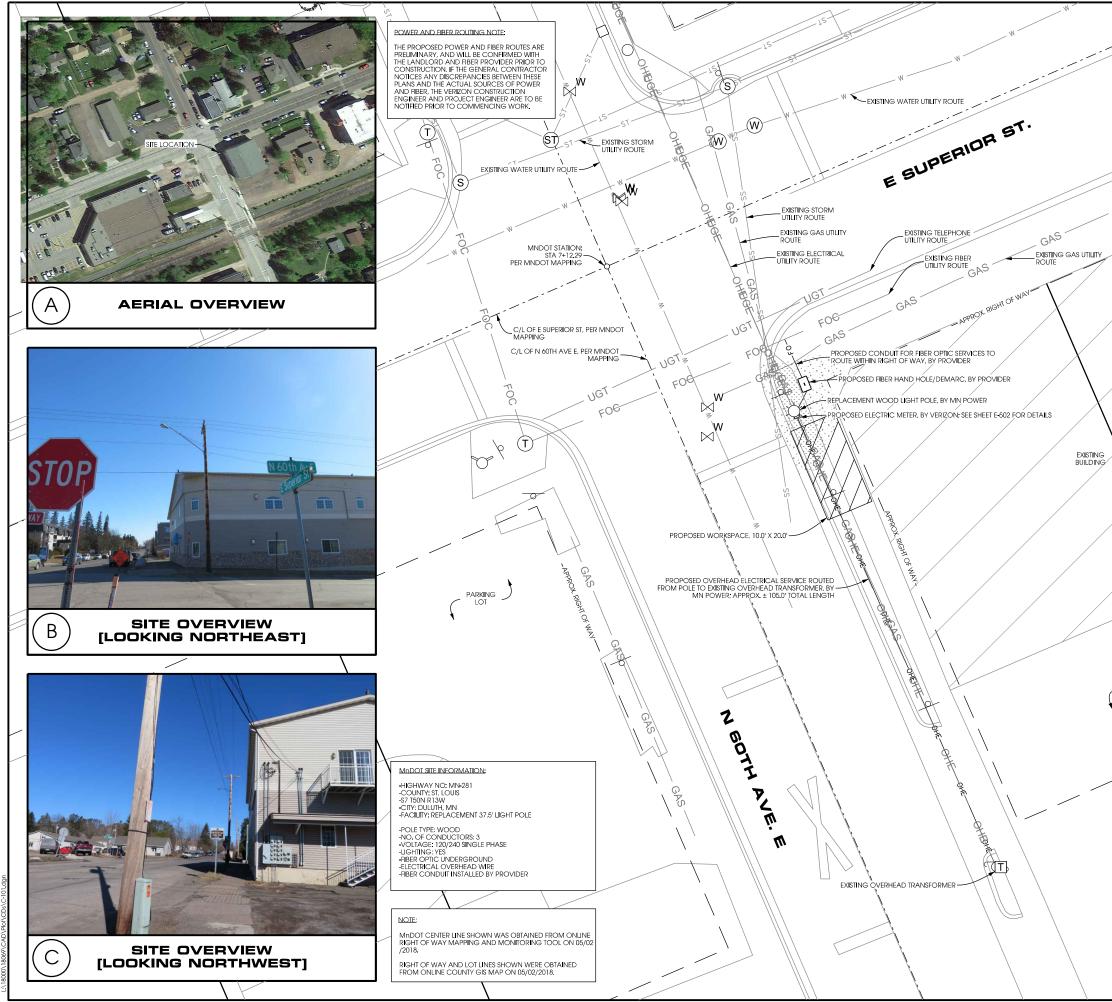

NORTH	verizon
GAS	JACOBS Jacobs Engineering Group, Inc 2727 Patton Road Roseville, Minnesota 55113 www.jacobs.com
GAS	Consulting Engineers, Inc. 2101 Highway 13 W Burnsville, MN 55337 408.6441.1549 fax www.edgeconsult.com
	PROJECT NO: 20171735330 LOCATION CODE: 484029 FD05 FD0 F00 NO: 18920
	EDGE PROJECT NO: 18069 CHECKED BY: OGD
PARKING LOT	REV. DATE DESCRIPTION INT. A 05/03/2018 PRELIM SMALL CELL DWGS ZRS B 05/15/2018 PRELIM SMALL CELL DWGS KJM C 05/17/2018 PRELIM SMALL CELL DWGS KJM 0 08/16/2018 FINAL SMALL CELL DWGS MWH 0 08/16/2018 FINAL SMALL CELL DWGS 0 08/16/2018 FINAL SMALL CELL DWGS
APPROX RIGHT OF WAY	I HEREBY CERTIFY THAT THIS PLAN, SPECFICATION, OR REPORT WAS PREPARED BY ME OR UNDER MY DIRECT SUPERVISION AND THAT I AM A DULY LICENSED PROFESSIONAL ENGINEER UNDER THE LAWS OF THE STATE OF MINNESOTA.
	DUL SUPER ONE SC1 1 DULUTH, MINNESOTA REPLACEMENT LIGHT POLE SMALL CELL DRAWINGS
	SHEET TITLE SITE PLAN
10' 0 10' 20' SCALE: 11" × 17" - 1" = 20' 22" × 34" - 1" = 10'	SHEET NUMBER

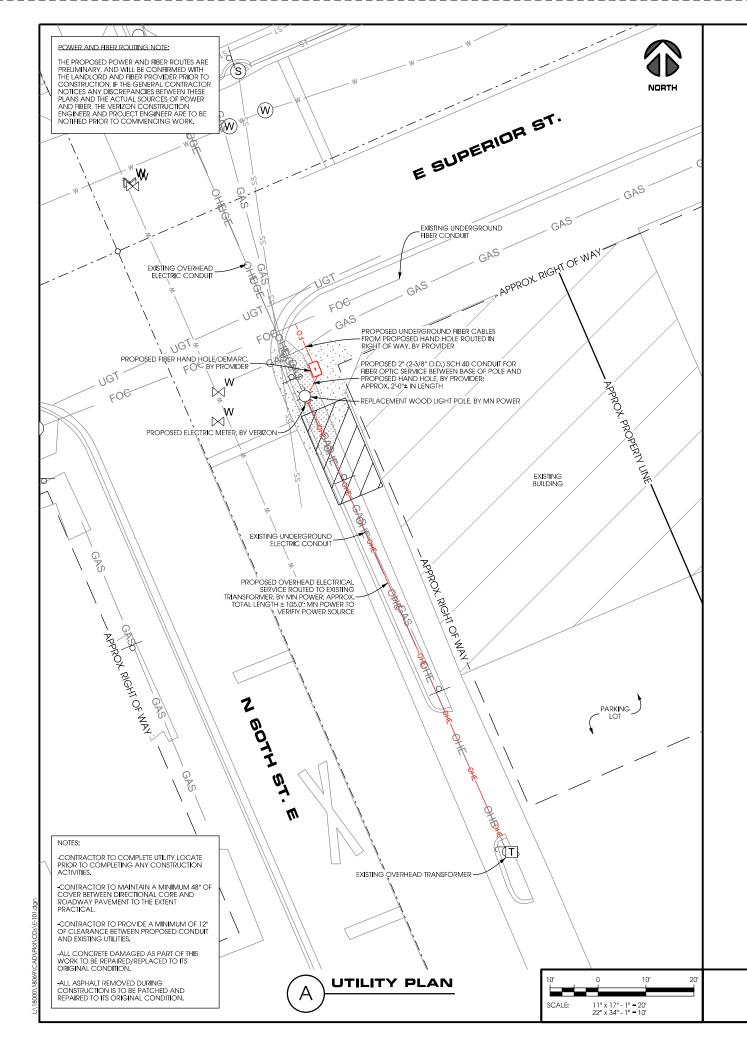


GENERAL ELECTRICAL NO


- 1. SUBMITTAL OF BID INDICATES CONTRACTOR IS AWARE OF ALL JOB SITE CONDITIONS AND WOR THIS CONTRACT.
- CONTRACTOR SHALL PERFORM ALL VERIFICATION OBSERVATION TESTS, AND EXAMINE WORK P ELECRTICAL EQUIPMENT AND THE ACTUAL CONSTRUCTION. CONTRACTOR SHALL ISSUE A WRITT THE ARCHITECT LISTING ALL MALFUNCTIONS, FAULTY EQUIPMENT AND DISCREPANCIES.
- 3. HEIGHTS SHALL BE VERIFIED WITH OWNER PRIOR TO INSTALLATION.
- 4. THESE PLANS ARE DIAGRAMMATIC ONLY. FOLLOW AS CLOSELY AS POSSIBLE.
- 5. EACH CONDUCTOR OF EVERY SYSTEM SHALL BE PERMANENTLY TAGGED IN EACH PANEL BOAR BOX, ETC. IN COMPLIANCE WITH OCCUPATIONAL SAFETY AND HEALTH ACT (O.S.H.A.)
- 6. CONTRACTOR SHALL PROVIDE LABOR, MATERIALS, INSURANCE, EQUIPMENT, INSTALLATION, CC TRANSPORTATION, ETC., FOR A COMPLETE AND PROPERLY OPERATIVE SYSTEM ENERGIZED THRO ON DRAWINGS, AS SPECIFIED HEREIN AND/OR AS OTHERWISE REQUIRED.
- 7. ALL MATERIALS AND EQUIPMENT SHALL BE NEW AND IN PERFECT CONDITION WHEN INSTALLED GRADE AND OF THE SAME MANUFACTURER THROUGHOUT FOR EACH CLASS OR GROUP OF EQU LISTED AND APPROVED BY THE UNDERWRITER'S LABORATORY AND SHALL BEAR THE INSPECTION SUCH APPROVAL. MATERIALS SHALL MEET WITH APPROVAL OF THE DIVISION OF INDUSTRIAL SAF BODIES HAVING JURISDICTION. MATERIALS SHALL BE MANUFACTURED IN ACCORDANCE WITH ESTABLISHED BY ANSI, NEMA, AND NBFU.
- 8. CONTRACTOR SHALL CARRY OUT HIS WORK IN ACCORDANCE WITH ALL GOVERNING STATE, C AND O.S.H.A.
- 9. CONTRACTOR SHALL SECURE ALL NECESSARY BUILDING PERMITS.
- 10. COMPLETE JOB SHALL BE GUARANTEED FOR A PERIOD OF ONE (1) YEAR AFTER THE DATE OF J ANY WORK, MATERIAL OR EQUIPMENT FOUND TO BE FAULTY DURING THAT PERIOD SHALL BE CO UPONWRITTEN NOTIFICATION, AT THE EXPENSE OF THE CONTRACTOR.
- 11. ALL CONDUIT ONLY (C.O.) SHALL HAVE A PULL WIRE OR ROPE.
- 12. PROVIDE CONSTRUCTION ENGINEER WITH ONE SET OF COMPLETE ELECTRICAL "AS INSTALLED" COMPLETION OF THE JOB, SHOWING ACTUAL DIMENSIONS, ROUTINGS, AND CIRCUITS.
- 13. ALL BROCHURES, OPERATING MANUALS, CATALOGS, SHOP DRAWINGS, ETC. SHALL BE TURNE
- 14. USE T-TAP CONNECTIONS ON ALL MULTI-CIRCUITS WITH COMMON NEUTRAL CONDUCTOR.
- 15. ALL CONDUCTORS SHALL BE COPPER.

COMPLETION.

- 6. ALL CIRCUIT BREAKERS, FUSES AND ELECTRICAL EQUIPMENT SHALL HAVE AN INTERRUPTING R. SHORT CIRCUIT CURRENT TO WHICH THEY MAY BE SUBJECTED, AND A MINIMUM OF 10,000 ALC
- 17. THE ENTIRE ELECTRICAL INSTALLATION SHALL BE GROUNDED AS REQUIRED BY ALL APPLICABLE
- 18. RECEPTACLES SHALL BE 20 AMPERE, 125 VOLT A.C., WHITE AS REQUIRED BY THE ARCHITECT OR
- 19. WALL SWITCHES SHALL BE SINGLE-POLE, HUBBELL #1201 OR EQUIVALENT, WHITE AS REQUIRED
- 20. PLASTIC PLATES FOR ALL SWITCHES, RECEPTACLES, TELEPHONE AND BLANKED OUTLETS, SHALL WHERE INDICATED ON THE DRAWINGS. WEATHERPROOF RECEPTACLES SHALL HAVE RACO #80
- WIRE AND CABLE CONDUCTORS SHALL BE COPPER #12 AWG MINIMUM, NO BX OR ROMEX C SPECIFICALLY NOTED OTHERWISE ON DRAWINGS.
- 22. GROUND RODS SHALL BE AS SPECIFIED ON THE GROUNDING DRAWINGS.
- 23. METER SOCKET AMPERES, VOLTAGE, NUMBER OF PHASES SHALL BE AS NOTED ON THE DRAWIN SQUARE D COMPANY OR APPROVED EQUAL. IF HOST FACILITY REQUIRES THE NEW SERVICE TO I EXISTING SERVICE, SUB-METER SHALL BE OF THE 10x OR 16x TYPE.
- 24. ALL MATERIALS SHALL BE U.L. LISTED.
- 25. CONDUIT: A. SERVICE CONDUITS SHALL BE GRAY SCH.40 PVC BURIED MIN. 36", EXCEPT THAT SCH.80 SHALL AND IN LOCATIONS SUBJECT TO CASUAL IMPACTS. BENDS SHALL BE MADE USING "WIDE SWEEP" HTITINGS. ANY CODE-REQUIRED RIGID STEEL CONDUIT SHALL BE UL. LABLE. GALVANIZED INSIDE / EXTEND MIN. 36" BELOW GRADE, WITH "SWEEP" ELBOWS (12" R. MIN) ENDING IN PVC TRANSITION CONTACT WITH EARTH SHALL BE 1/2 LAP-WRAPPED WITH HUNTS PROCESS NO. 3 EXTENDING MIN
- B. INTERIOR CONDUITS SHALL BE ELECTRICAL METALLIC TUBING HAVING U.L. LABEL, FITTINGS SH. COMPRESSION TYPE.
- C. FLEXIBLE METALLIC CONDUIT SHALL HAVE U.L. LISTED LABEL AND MAY BE USED WHERE PERMIT BE "JAKE" OR "SQUEEZE" TYPE, SEAL TIGHT FLEXIBLE CONDUIT. NO SUCH CONDUIT SHALL EXCEED
- 26. ALL ELECTRICAL EQUIPMENT SHALL BE LABELED WITH PERMANENT ENGRAVED PLASTIC LABEL
- 27. PATCH, REPAIR, AND PAINT ANY AREA THAT HAS BEEN DAMAGED IN THE COURSE OF THE ELEC
- 28. PENETRATIONS IN FIRE RATED WALLS SHALL BE FIRE STOPPED IN ACCORDANCE WITH SECTION INTERNATIONAL BUILDING CODE (IBC)
- 29. DRILLING OR CORING HOLES IN CONCRETE WALLS OR DECKS, WHETHER FOR FASTENING OR A REQUIRES THAT TENDONS OR REINFORCING STEEL MUST BE SEARCHED FOR BY APPROPRIATE ME OR OTHER DEVICE) THAT CAN ACCURATELY LOCATE THEM, TENDONS OR REINFORCING MUST M DAMAGED UNDER ANY CIRCUMSTANCES
- 30. UPON COMPLETION OF WORK, CONDUCT CONTINUITY, SHOPT ORCUIT, AND FALL POTENTIAL APPROVAL, SUBMIT TEST REPORTS TO CONSTRUCTION ENGINEER, CLEAN PREMISES OF ALL DEBI AND LEAVE WORK IN A COMPLETE AND UNDAMAGED CONDITION.
- 31. CONTRACTOR TO COORDINATE WITH UTILITY COMPANY FOR CONNECTION OF BOTH TEMPO TO THE SITE. THE TEMPORARY POWER AND ALL HOOKUP COSTS TO BE PAID BY CONTRACTOR.
- 32. CONTRACTOR SHALL PROVIDE LABOR AND MATERIALS AS NECESSARY TO COMPLETE THE INS LIGHTING SYSTEM DESCRIBED IN THE RFQ.

	verizon
rk to be performed under Prior to the ordering of the Ten notice of All findings to	Jacobs Engineering Group, Inc 2727 Potton Road Roseville, Minnesota 55113 www.jacobs.com
RD, PULLBOX, J B OX, SWITCH DNSTRUCTION TOOLS, JUGHOUT AND AS INDICATED	
AND SHALL BE OF THE BEST UIPMENT, MATERIALS SHALL BE I LABEL "," WHERE SUBJECT TO FETV AND ALL GOVERNING APPLICABLE STANDARDS COUNTY AND LOCAL CODES	Consulting Engineers, Inc. 2101 Highway 13 W Burnsville, MN 55337 608.644.1249 voice 0.08.644.1549 fax www.edgeconsult.com
IOB ACCEPTANCE BY OWNER, DRRECTED AT ONCE,	PROJECT NO: 20171735330 LOCATION CODE: 484029
" DRAWINGS AT THE D OVER TO OWNER AT JOB	EDGE PROJECT NO: 18069 CHECKED BY: OGD (Rev.) Date Description INT.
ATING NOT LESS THE MAXIMUM E CODES AND DRAWINGS. R APPROVED EQUAL BY THE ARCHITECT HAVE ENGRAVED LETTERING 10, 1/2" RAISED WORK COVERS. :ABLE IS PERMITTED UNLESS	A 05/03/2018 PRELIM SMALL CELL DWGS RRS B 05/15/2018 PRELIM SMALL CELL DWGS MWH C 05/17/2018 PRELIM SMALL CELL DWGS KJM 0 08/16/2018 FINAL SMALL CELL DWGS MWH 1 1 1 1 1 1 1 1 1 1 1 1 1 1 1 1
NGS. MANUFACTURED BY BE SUB-METERED FROM THE	
BE USED UNDER ROADWAYS P* (12* MIN. RADIUS) ELBOW AND OUTSIDE. CONDUIT SHALL IN HITINGS. RIGID CONDUIT IN N. 12* ABOVE GRADE. ALL BE GLAND RING TIED BY CODE. HTTINGS SHALL D SIX FEET IN LENGTH. 3.	APPROVED FOR
Trical Work. 712, Penetrations - Anchoring Purposes, Ethods and Equipment (X-ray Not Be Drilled, Cut or	I HEREBY CERTIFY THAT THIS PLAN, SPECFICATION, OR REPORT WAS PREPARED BY ME OR UNDER MY DIRECT SUPERVISION AND THAT I AM A DULY LICENSED PROFESSIONAL ENGINEER UNDER THE LAWS OF THE STATE OF MINNESOTA.
GROUNDING TESTS FOR IRIS RESULTING FROM WORK RARY AND PERMANENT POWER TALLATION OF ANY TOWER	DUL SUPER ONE SC1 1 DULUTH, MINNESOTA REPLACEMENT LIGHT POLE SMALL CELL DRAWINGS
	SHEET TITLE UTILITY PLAN
TES	SHEET NUMBER

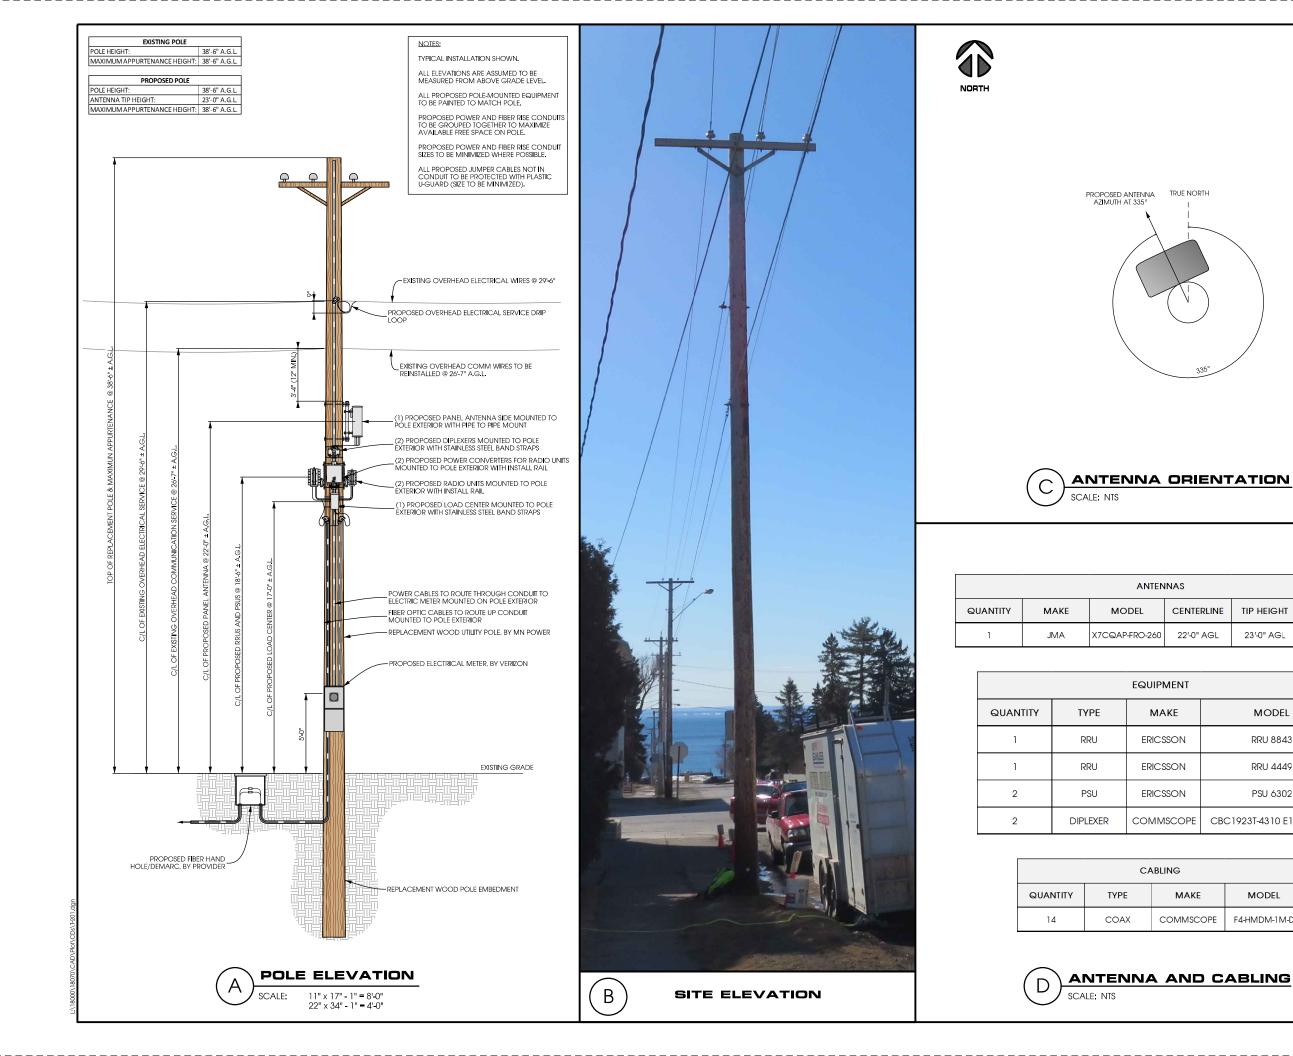

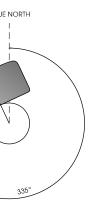


.S		
ENTERLINE	TIP HEIGHT	AZIMUTH
22'-0" AGL	23'-0" AGL	335°

NT	
	MODEL
N	RRU 8843
Ν	RRU 4449
N	PSU 6302
OPE	CBC1923T-4310 E11F13PO6

;	
NAKE	MODEL
1MSCOPE	F4-HMDM-1M-D

	vei	rizon ⁄			
	JACOBS Jacobs Engineering Group, Inc 2727 Patton Road Roseville, Minnesota 55113 www.jacobs.com				
	Consulting Engineers, Inc. 2101 Highway 13 W Burrsville, MN 56337 608.644.1649 vaice 608.644.1649 fax www.edgeconsult.com				
PRC	JECT NO:	: 20171735331)		
LOC	CATION CO	ODE: 484030	1		
EDG	SE PROJEC	CT NO: 18070	1		
	CKED BY:		1		
REV.	DATE	DESCRIPTION INT	-		
	05/07/2018 05/14/2018	PRELIM SMALL CELL DWGS ZRS	-		
	05/17/2018	PRELIM SMALL CELL DWGS KJW	-		
0	08/21/2018	FINAL SMALL CELL DWGS MW			
	08/21/2018	FINAL SMALL CELL DWGS MW	-		
			1		
┛匚┤					
			+		
			1		
			J		
	THEREBY CERTIFY THAT THIS PLAN, SPECFICATION, ARTHER, METHOD SHAP, OR REPORT WAS PREPARED BY ME OR UNDER MY DIRECT SUPERVISION AND THAT I AM A DULY LICENSED PROFESSIONAL ENGINEER UNDER THE LAWS OF THE STATE OF MINNESOTA. DULL SUPER ONE SC1 2 DULUTH, MINNESOTA REPLACEMENT UTILITY POLE SMALL CELL DRAWINGS				
	SHEET NUMBER				
	T-201				



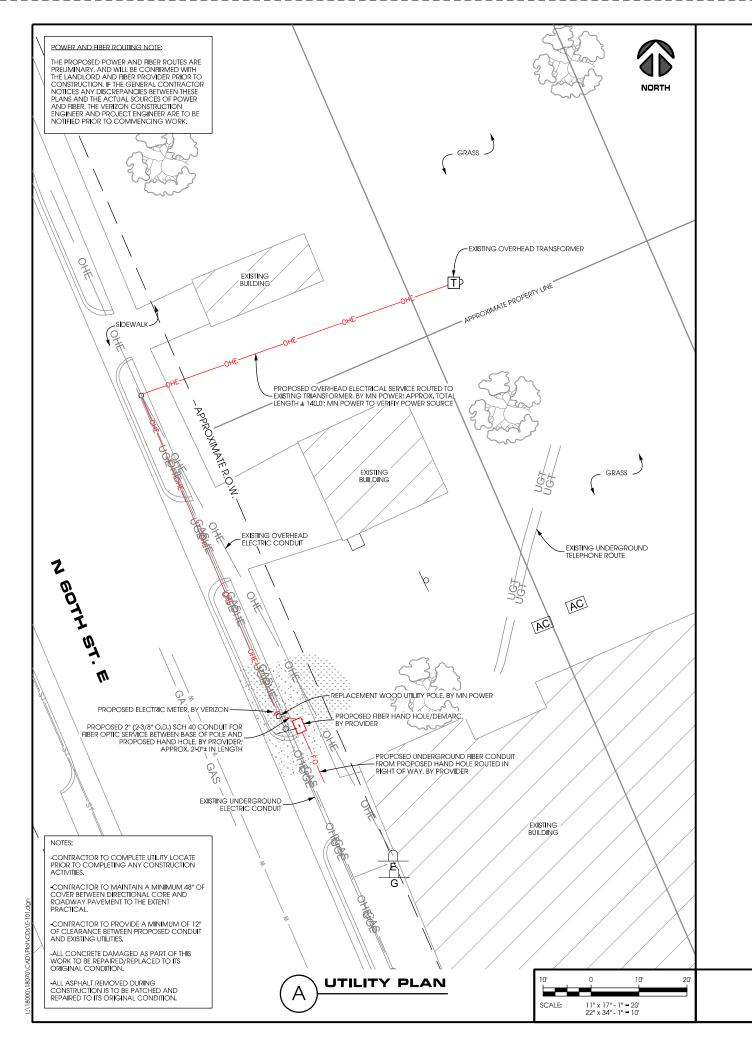



- 1. SUBMITTAL OF BID INDICATES CONTRACTOR IS AWARE OF ALL JOB SITE CONDITIONS AND WOR THIS CONTRACT.
- CONTRACTOR SHALL PERFORM ALL VERIFICATION OBSERVATION TESTS, AND EXAMINE WORK P ELECRTICAL EQUIPMENT AND THE ACTUAL CONSTRUCTION. CONTRACTOR SHALL ISSUE A WRITT THE ARCHITECT LISTING ALL MALFUNCTIONS, FAULTY EQUIPMENT AND DISCREPANCIES.
- 3. HEIGHTS SHALL BE VERIFIED WITH OWNER PRIOR TO INSTALLATION.
- 4. THESE PLANS ARE DIAGRAMMATIC ONLY. FOLLOW AS CLOSELY AS POSSIBLE.
- 5. EACH CONDUCTOR OF EVERY SYSTEM SHALL BE PERMANENTLY TAGGED IN EACH PANEL BOAR BOX, ETC. IN COMPLIANCE WITH OCCUPATIONAL SAFETY AND HEALTH ACT (O.S.H.A.)
- 6. CONTRACTOR SHALL PROVIDE LABOR, MATERIALS, INSURANCE, EQUIPMENT, INSTALLATION, CC TRANSPORTATION, ETC., FOR A COMPLETE AND PROPERLY OPERATIVE SYSTEM ENERGIZED THRO ON DRAWINGS, AS SPECIFIED HEREIN AND/OR AS OTHERWISE REQUIRED.
- 7. ALL MATERIALS AND EQUIPMENT SHALL BE NEW AND IN PERFECT CONDITION WHEN INSTALLED GRADE AND OF THE SAME MANUFACTURER THROUGHOUT FOR EACH CLASS OR GROUP OF EQU LISTED AND APPROVED BY THE UNDERWRITER'S LABORATORY AND SHALL BEAR THE INSPECTION SUCH APPROVAL. MATERIALS SHALL MEET WITH APPROVAL OF THE DIVISION OF INDUSTRIAL SAF BODIES HAVING JURISDICTION. MATERIALS SHALL BE MANUFACTURED IN ACCORDANCE WITH ESTABLISHED BY ANSI, NEMA, AND NBFU.
- 8. CONTRACTOR SHALL CARRY OUT HIS WORK IN ACCORDANCE WITH ALL GOVERNING STATE, C AND O.S.H.A.
- 9. CONTRACTOR SHALL SECURE ALL NECESSARY BUILDING PERMITS.
- 10. COMPLETE JOB SHALL BE GUARANTEED FOR A PERIOD OF ONE (1) YEAR AFTER THE DATE OF J ANY WORK, MATERIAL OR EQUIPMENT FOUND TO BE FAULTY DURING THAT PERIOD SHALL BE CO UPONWRITTEN NOTIFICATION, AT THE EXPENSE OF THE CONTRACTOR.
- 11. ALL CONDUIT ONLY (C.O.) SHALL HAVE A PULL WIRE OR ROPE.
- 12. PROVIDE CONSTRUCTION ENGINEER WITH ONE SET OF COMPLETE ELECTRICAL "AS INSTALLED" COMPLETION OF THE JOB, SHOWING ACTUAL DIMENSIONS, ROUTINGS, AND CIRCUITS.
- 13. ALL BROCHURES, OPERATING MANUALS, CATALOGS, SHOP DRAWINGS, ETC. SHALL BE TURNE
- COMPLETION. 14. USE T-TAP CONNECTIONS ON ALL MULTI-CIRCUITS WITH COMMON NEUTRAL CONDUCTOR.
- 15. ALL CONDUCTORS SHALL BE COPPER.
- 16. ALL CIRCUIT BREAKERS, FUSES AND ELECTRICAL EQUIPMENT SHALL HAVE AN INTERRUPTING R. SHORT CIRCUIT CURRENT TO WHICH THEY MAY BE SUBJECTED, AND A MINIMUM OF 10,000 ALC
- 17. THE ENTIRE ELECTRICAL INSTALLATION SHALL BE GROUNDED AS REQUIRED BY ALL APPLICABLE
- 18. RECEPTACLES SHALL BE 20 AMPERE, 125 VOLT A.C., WHITE AS REQUIRED BY THE ARCHITECT OR
- 19. WALL SWITCHES SHALL BE SINGLE-POLE, HUBBELL #1201 OR EQUIVALENT, WHITE AS REQUIRED
- 20. PLASTIC PLATES FOR ALL SWITCHES, RECEPTACLES, TELEPHONE AND BLANKED OUTLETS, SHALL WHERE INDICATED ON THE DRAWINGS. WEATHERPROOF RECEPTACLES SHALL HAVE RACO #80
- WIRE AND CABLE CONDUCTORS SHALL BE COPPER #12 AWG MINIMUM, NO BX OR ROMEX C SPECIFICALLY NOTED OTHERWISE ON DRAWINGS.
- 22. GROUND RODS SHALL BE AS SPECIFIED ON THE GROUNDING DRAWINGS.
- 23. METER SOCKET AMPERES, VOLTAGE, NUMBER OF PHASES SHALL BE AS NOTED ON THE DRAWIN SQUARE D COMPANY OR APPROVED EQUAL. IF HOST FACILITY REQUIRES THE NEW SERVICE TO I EXISTING SERVICE, SUB-METER SHALL BE OF THE 10x OR 16x TYPE.
- 24. ALL MATERIALS SHALL BE U.L. LISTED.


- 25. CONDUIT: A. SERVICE CONDUITS SHALL BE GRAY SCH.40 PVC BURIED MIN. 36", EXCEPT THAT SCH.80 SHALL B AND IN LOCATIONS SUBJECT TO CASUAL IMPACTS. BENDS SHALL BE MADE USING "WIDE SWEEP" HTITINGS. ANY CODE-REQUIRED RIGID STEEL CONDUIT SHALL BE ULL LABLE, GALVANIZED INSIDE / EXTEND MIN, 36" BELOW GRADE, WITH "SWEEP" ELBOWS (12" R, MIN,) ENDING IN PVC TRANSITION CONTACT WITH EARTH SHALL BE 1/2 LAP-WRAPPED WITH HUNTS PROCESS NO. 3 EXTENDING MIN
- B. INTERIOR CONDUITS SHALL BE ELECTRICAL METALLIC TUBING HAVING U.L. LABEL, FITTINGS SH/ COMPRESSION TYPE.
- C. FLEXIBLE METALLIC CONDUIT SHALL HAVE U.L. LISTED LABEL AND MAY BE USED WHERE PERMIT BE "JAKE" OR "SQUEEZE" TYPE, SEAL TIGHT FLEXIBLE CONDUIT. NO SUCH CONDUIT SHALL EXCEED


- 26. ALL ELECTRICAL EQUIPMENT SHALL BE LABELED WITH PERMANENT ENGRAVED PLASTIC LABEL

	verizon
1. SUBMITTAL OF BID INDICATES CONTRACTOR IS AWARE OF ALL JOB SITE CONDITIONS AND WORK TO BE PERFORMED UNDER THIS CONTRACT.	
2. CONTRACTOR SHALL PERFORM ALL VERIFICATION OBSERVATION TESTS, AND EXAMINE WORK PRIOR TO THE ORDERING OF THE ELECRITICAL EQUIPMENT AND THE ACTUAL CONSTRUCTION. CONTRACTOR SHALL ISSUE A WRITTEN NOTICE OF ALL FINDINGS TO THE ARCHITECT LISTING ALL MALFUNCTIONS, FAULTY EQUIPMENT AND DISCREPANCIES.	
3. HEIGHTS SHALL BE VERIFIED WITH OWNER PRIOR TO INSTALLATION.	2727 Patton Road RosevI ll e, Minnesota 55113
4. THESE PLANS ARE DIAGRAMMATIC ONLY. FOLLOW AS CLOSELY AS POSSIBLE.	www.jacobs.com
5. EACH CONDUCTOR OF EVERY SYSTEM SHALL BE PERMANENTLY TAGGED IN EACH PANEL BOARD, PULLBOX, JBOX, SWITCH BOX, ETC, IN COMPLIANCE WITH OCCUPATIONAL SAFETY AND HEALTH ACT (O.S.H.A.)	
6. CONTRACTOR SHALL PROVIDE LABOR, MATERIALS, INSURANCE, EQUIPMENT, INSTALLATION, CONSTRUCTION TOOLS, TRANSPORTATION, ETC., FOR A COMPLETE AND PROPERLY OPERATIVE SYSTEM ENERGIZED THROUGHOUT AND AS INDICATED ON DRAWINGS, AS SPECIFIED HEREIN AND/OR AS OTHERWISE REQUIRED.	
7. ALL MATERIALS AND EQUIPMENT SHALL BE NEW AND IN PERFECT CONDITION WHEN INSTALLED AND SHALL BE OF THE BEST GRADE AND OF THE SAME MANUFACTURER THROUGHOUT FOR EACH CLASS OR GROUP OF EQUIPMENT. MATERIALS SHALL BE LISTED AND APPROVED BY THE UNDERWRITER'S LABORATORY AND SHALL BEAR THE INSPECTION LABEL."" WHERE SUBJECT TO SUCH APPROVAL. MATERIALS SHALL MEET WITH APPROVAL OF THE DIVISION OF INDUSTRIAL SAFETY AND ALL GOVERNING BODIES HAVING JUREDICTION. MATERIALS SHALL BE MANUFACTURED IN ACCORDANCE WITH APPLICABLE STANDARDS ESTABLISHED BY ANSI, NEMA, AND NBFU.	Consulting Engineers, Inc. 2101 Highway 13 W Burnsville, MN 55337 608.644.1549 voice 608.644.1549 fax
 CONTRACTOR SHALL CARRY OUT HIS WORK IN ACCORDANCE WITH ALL GOVERNING STATE, COUNTY AND LOCAL CODES AND O.S.H.A. 	www.edgeconsult.com
9. CONTRACTOR SHALL SECURE ALL NECESSARY BUILDING PERMITS.	
10. COMPLETE JOB SHALL BE GUARANTEED FOR A PERIOD OF ONE (1) YEAR AFTER THE DATE OF JOB ACCEPTANCE BY OWNER. ANY WORK, MATERIAL OR EQUIPMENT FOUND TO BE FAULTY DURING THAT PERIOD SHALL BE CORRECTED AT ONCE, UPONWRITTEN NOTIFICATION, AT THE EXPENSE OF THE CONTRACTOR.	PROJECT NO: 20171735331 LOCATION CODE: 484030
11. ALL CONDUIT ONLY (C.O.) SHALL HAVE A PULL WIRE OR ROPE.	EDGE PROJECT NO: 18070
12. PROVIDE CONSTRUCTION ENGINEER WITH ONE SET OF COMPLETE ELECTRICAL "AS INSTALLED" DRAWINGS AT THE COMPLETION OF THE JOB, SHOWING ACTUAL DIMENSIONS, ROUTINGS, AND CIRCUITS.	CHECKED BY: OGD
13. ALL BROCHURES, OPERATING MANUALS, CATALOGS, SHOP DRAWINGS, ETC. SHALL BE TURNED OVER TO OWNER AT JOB COMPLETION.	REV. DATE DESCRIPTION INT.
14. USE T-TAP CONNECTIONS ON ALL MULTI-CIRCUITS WITH COMMON NEUTRAL CONDUCTOR.	A 05/07/2018 PRELIM SMALL CELL DWGS ZRS
15. ALL CONDUCTORS SHALL BE COPPER.	B 05/14/2018 PRELIM SMALL CELL DWGS MWH C 05/17/2018 PRELIM SMALL CELL DWGS KJM
 ALL CIRCUIT BREAKERS, FUSES AND ELECTRICAL EQUIPMENT SHALL HAVE AN INTERRUPTING RATING NOT LESS THE MAXIMUM SHORT CIRCUIT CURRENT TO WHICH THEY MAY BE SUBJECTED, AND A MINIMUM OF 10,000 A.LC. 	
17. THE ENTIRE ELECTRICAL INSTALLATION SHALL BE GROUNDED AS REQUIRED BY ALL APPLICABLE CODES AND DRAWINGS.	0 08/21/2018 FINAL SMALL CELL DWGS MWH 1 08/22/2018 FINAL SMALL CELL DWGS MWH
 RECEPTACLES SHALL BE 20 AMPERE, 125 VOLT A.C., WHITE AS REQUIRED BY THE ARCHITECT OR APPROVED EQUAL WALL SWITCHES SHALL BE SINGLE-POLE, HUBBELL #1201 OR EQUIVALENT, WHITE AS REQUIRED BY THE ARCHITECT. 	
20. PLASTIC PLATES FOR ALL SWITCHES, RECEPTACLES, TELEPHONE AND BLANKED OUTLETS, SHALL HAVE ENGRAVED LETTERING	
WHERE INDICATED ON THE DRAWINGS. WEATHERPROOF RECEPTACLES SHALL HAVE RACO #800, 1/2" RAISED WORK COVERS. 21. WIRE AND CABLE CONDUCTORS SHALL BE COPPER #12 AWG MINIMUM, NO BX OR ROMEX CABLE IS PERMITTED UNLESS	
SPECIFICALLY NOTED OTHERWISE ON DRAWINGS. 22. GROUND RODS SHALL BE AS SPECIFIED ON THE GROUNDING DRAWINGS.	
23. METER SOCKET AMPERES, VOLTAGE, NUMBER OF PHASES SHALL BE AS NOTED ON THE DRAWINGS. MANUFACTURED BY	
SQUARE D COMPANY OR APPROVED EQUAL. IF HOST FACILITY REQUIRES THE NEW SERVICE TO BE SUB-METERED FROM THE EXISTING SERVICE, SUB-METER SHALL BE OF THE 10x OR 16x TYPE.	
24. ALL MATERIALS SHALL BE U.L. LISTED.	\$, O
25. CONDUIT: A. SERVICE CONDUITS SHALL BE GRAY SCH.40 PVC BURIED MIN. 36", EXCEPT THAT SCH.80 SHALL BE USED UNDER ROADWAYS AND IN LOCATIONS SUBJECT TO CASUAL IMPACTS. BENDS SHALL BE MADE USING "WIDE SWEEP" (12" MIN. RADIUS) ELBOW HTTINGS. ANY CODE-REQUIRED RIGID STEEL CONDUIT SHALL BE U.L. LABEL GALVANIZED INSIDE AND OUTSIDE. CONDUIT SHALL EXTEND MIN. 36" BELOW GRADE. WITH "SWEEP" ELBOWS (12" R. MIN.) ENDING IN PVC TRANSITION HITTINGS. RIGID CONDUIT IN CONTACT WITH EARTH SHALL BE 1/2 LAP-WIRAPPED WITH HUNTS PROCESS NO. 3 EXTENDING MIN. 12" ABOVE GRADE.	APPROVED FOR SEESHEEINERSEAL
B. INTERIOR CONDUITS SHALL BE ELECTRICAL METALLIC TUBING HAVING U.L. LABEL, FITTINGS SHALL BE GLAND RING COMPRESSION TYPE.	SHEARE
C. FLEXIBLE METALLIC CONDUIT SHALL HAVE U.L. USTED LABEL AND MAY BE USED WHERE PERMITTED BY CODE. HTTINGS SHALL BE "JAKE" OR "SQUEEZE" TYPE, SEAL TIGHT FLEXIBLE CONDUIT. NO SUCH CONDUIT SHALL EXCEED SIX FEET IN LENGTH.	SHE HAD
26. ALL ELECTRICAL EQUIPMENT SHALL BE LABELED WITH PERMANENT ENGRAVED PLASTIC LABELS.	
27. PATCH, REPAIR, AND PAINT ANY AREA THAT HAS BEEN DAMAGED IN THE COURSE OF THE ELECTRICAL WORK.	I HEREBY CERTIFY THAT THIS PLAN, SPECFICATION,
28. PENETRATIONS IN FIRE RATED WALLS SHALL BE FIRE STOPPED IN ACCORDANCE WITH SECTION 712, PENETRATIONS - INTERNATIONAL BUILDING CODE (IBC)	OR REPORT WAS PREPARED BY ME OR UNDER MY DIRECT SUPERVISION AND THAT I AM A DULY
29. DRILLING OR CORING HOLES IN CONCRETE WALLS OR DECKS, WHETHER FOR FASTENING OR ANCHORING PURPOSES. REQUIRES THAT TENDONS OR REINFORCING STEEL MUST BE SEARCHED FOR BY APPROPRIATE METHODS AND EQUIPMENT (X-RAY OR OTHER DEVICE) THAT CAN ACCURATELY LOCATE THEM. TENDONS OR REINFORCING MUST NOT BE DRILLED, CUT OR DAMAGED UNDER ANY CIRCUMSTANCES.	LICENSED PROFESSIONAL ENGINEER UNDER THE LAWS OF THE STATE OF MINNESOTA.
30, UPON COMPLETION OF WORK, CONDUCT CONTINUITY, SHORT CIRCUIT, AND FALL POTENTIAL GROUNDING TESTS FOR APPROVAL. SUBMIT TEST REPORTS TO CONSTRUCTION ENGINEER. CLEAN PREMISES OF ALL DEBRIS RESULTING FROM WORK AND LEAVE WORK IN A COMPLETE AND UNDAMAGED CONDITION.	DUL SUPER ONE SC1 2 DULUTH, MINNESOTA
31. CONTRACTOR TO COORDINATE WITH UTILITY COMPANY FOR CONNECTION OF BOTH TEMPORARY AND PERMANENT POWER TO THE SITE. THE TEMPORARY POWER AND ALL HOCKUP COSTS TO BE PAID BY CONTRACTOR.	REPLACEMENT UTILITY POLE
32. CONTRACTOR SHALL PROVIDE LABOR AND MATERIALS AS NECESSARY TO COMPLETE THE INSTALLATION OF ANY TOWER LIGHTING SYSTEM DESCRIBED IN THE RFQ.	SMALL CELL DRAWINGS
	SHEET TITLE
	UTILITY PLAN
	SHEET NUMBER
GENERAL ELECTRICAL NOTES	E-101

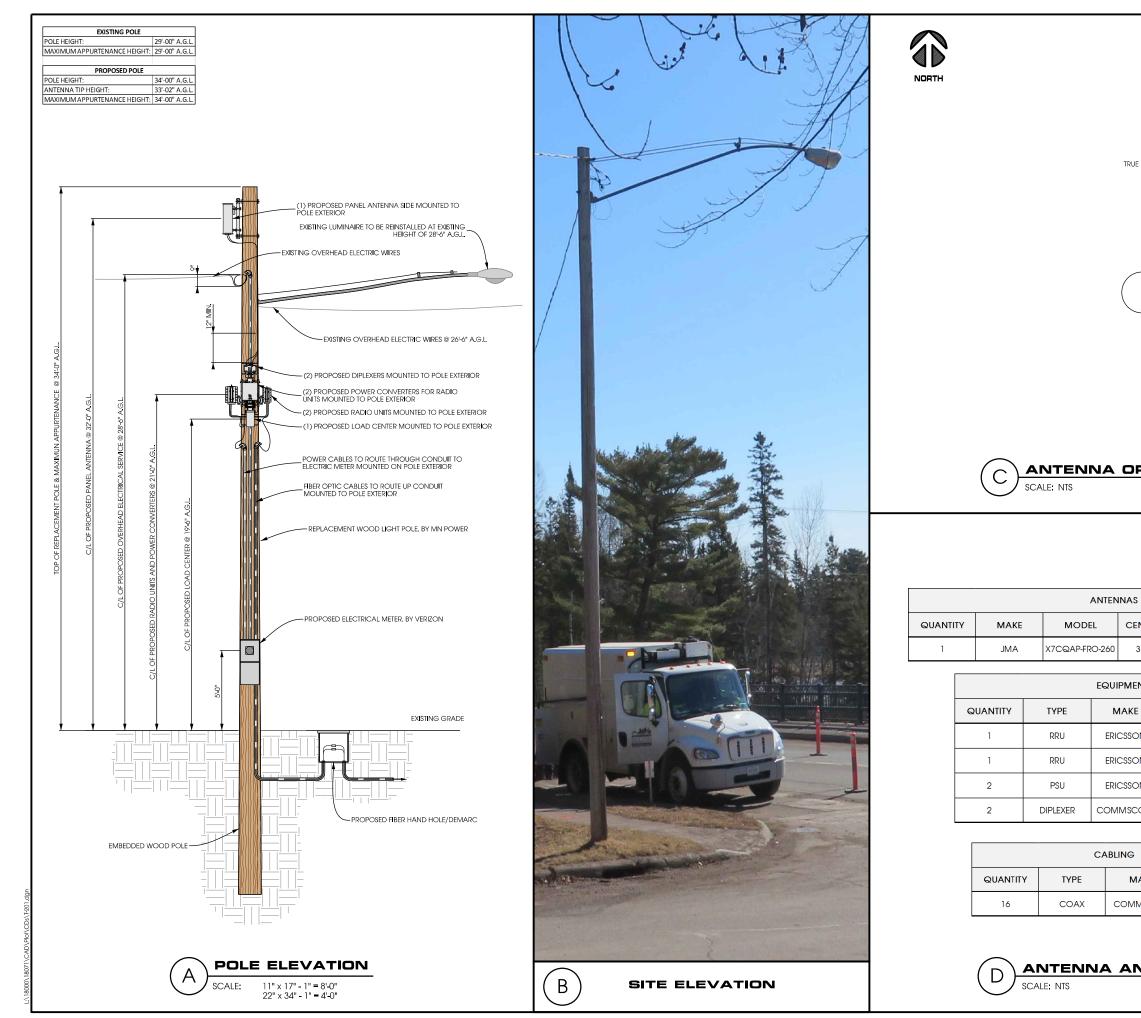

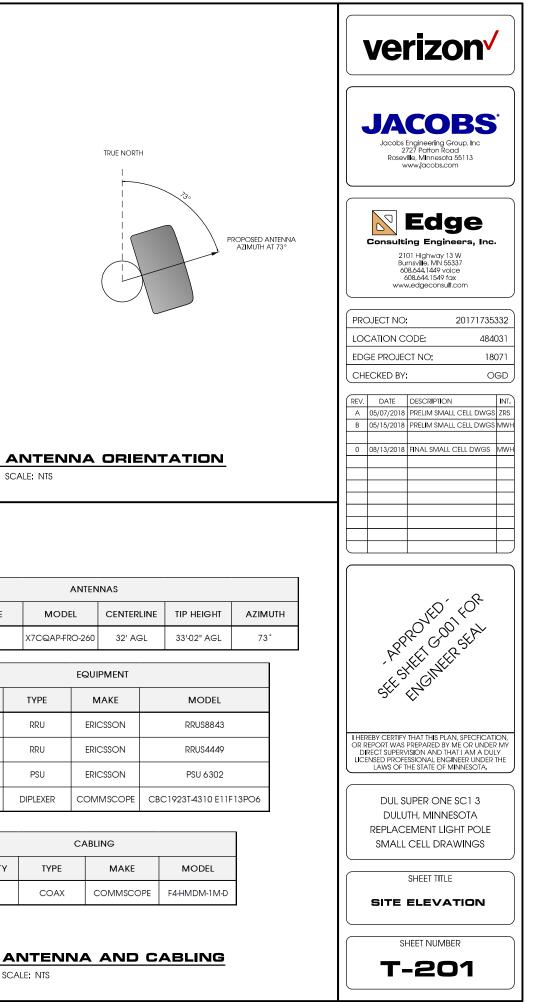

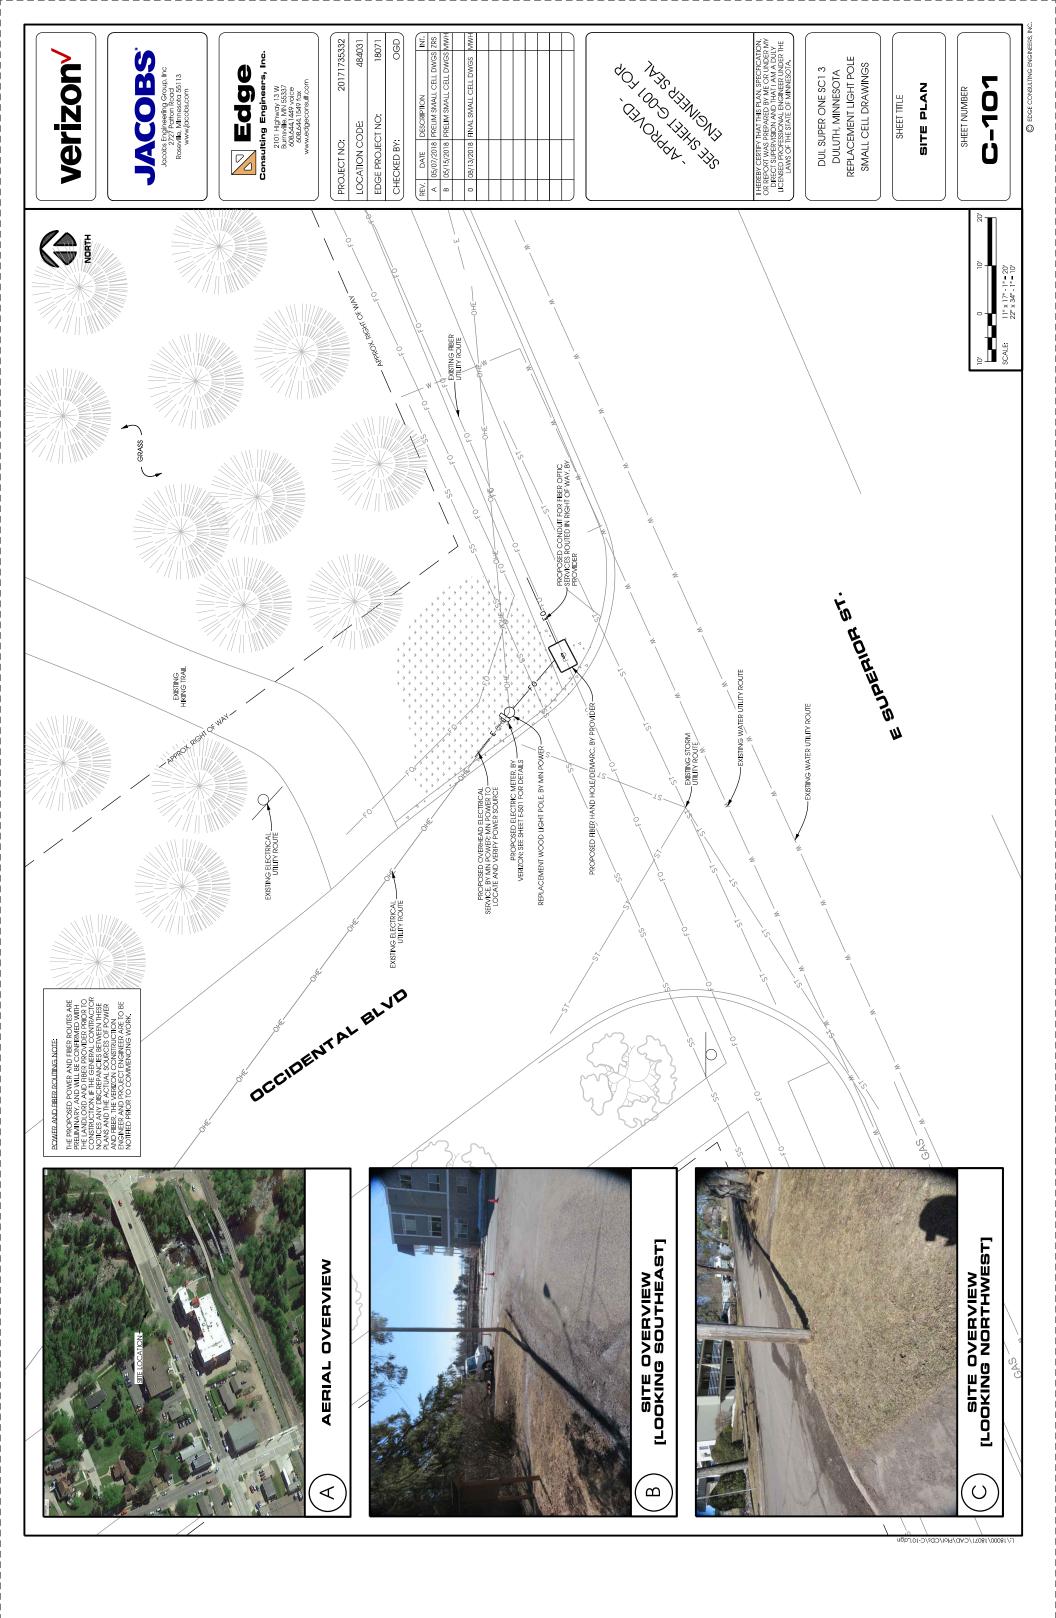

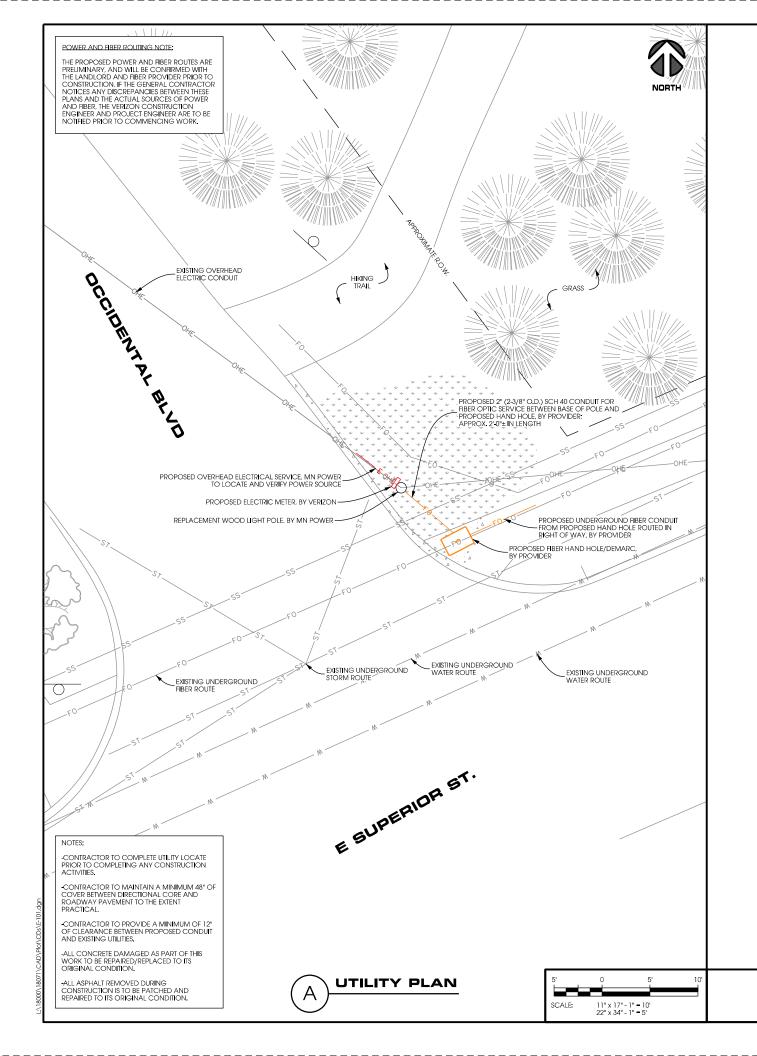

- 1. SUBMITTAL OF BID INDICATES CONTRACTOR IS AWARE OF ALL JOB SITE CONDITIONS AND WOR THIS CONTRACT.
- 2. CONTRACTOR SHALL PERFORM ALL VERIFICATION OBSERVATION TESTS, AND EXAMINE WORK P ELECRTICAL EQUIPMENT AND THE ACTUAL CONSTRUCTION. CONTRACTOR SHALL ISSUE A WRITT THE ARCHITECT LISTING ALL MALFUNCTIONS, FAULTY EQUIPMENT AND DISCREPANCIES.
- 3. HEIGHTS SHALL BE VERIFIED WITH OWNER PRIOR TO INSTALLATION.
- THESE PLANS ARE DIAGRAMMATIC ONLY. FOLLOW AS CLOSELY AS POSSIBLE.
 EACH CONDUCTOR OF EVERY SYSTEM SHALL BE PERMANENTLY TAGGED IN EACH PANEL BOARD BOX, ETC. IN COMPLIANCE WITH OCCUPATIONAL SAFETY AND HEALTH ACT (O.S.H.A.)
- 6. CONTRACTOR SHALL PROVIDE LABOR, MATERIALS, INSURANCE, EQUIPMENT, INSTALLATION, CON TRANSPORTATION, ETC., FOR A COMPLETE AND PROPERLY OPERATIVE SYSTEM ENERGIZED THROU ON DRAWINGS, AS SPECIFIED HEREIN AND/OR AS OTHERWISE REQUIRED.
- 7. ALL MATERIALS AND EQUIPMENT SHALL BE NEW AND IN PERFECT CONDITION WHEN INSTALLED / GRADE AND OF THE SAME MANUFACTURER THROUGHOUT FOR EACH CLASS OR GROUP OF EQU LISTED AND APPROVED BY THE UNDERWRITER'S LABORATORY AND SHALL BEAR THE INSPECTION I SUCH APPROVAL. MATERIALS SHALL MEET WITH APPROVAL OF THE DIVISION OF INDUSTRIAL SAFI BODIES HAVING JURISDICTION. MATERIALS SHALL BE MANUFACTURED IN ACCORDANCE WITH A ESTABLISHED BY ANS, INFMA, AND NBFU.
- CONTRACTOR SHALL CARRY OUT HIS WORK IN ACCORDANCE WITH ALL GOVERNING STATE, CO AND O.S.H.A.
- 9. CONTRACTOR SHALL SECURE ALL NECESSARY BUILDING PERMITS.
- COMPLETE JOB SHALL BE GUARANTEED FOR A PERIOD OF ONE (1) YEAR AFTER THE DATE OF JC ANY WORK, MATERIAL OR EQUIPMENT FOUND TO BE FAULTY DURING THAT PERIOD SHALL BE COU UPONWRITTEN NOTIFICATION, AT THE EXPENSE OF THE CONTRACTOR.
- 11. ALL CONDUIT ONLY (C.O.) SHALL HAVE A PULL WIRE OR ROPE.
- 12. PROVIDE CONSTRUCTION ENGINEER WITH ONE SET OF COMPLETE ELECTRICAL "AS INSTALLED" I COMPLETION OF THE JOB, SHOWING ACTUAL DIMENSIONS, ROUTINGS, AND CIRCUITS.
- 13. ALL BROCHURES, OPERATING MANUALS, CATALOGS, SHOP DRAWINGS, ETC. SHALL BE TURNE
- 14. USE T-TAP CONNECTIONS ON ALL MULTI-CIRCUITS WITH COMMON NEUTRAL CONDUCTOR.
- 15. ALL CONDUCTORS SHALL BE COPPER.

COMPLETION.

- 16. ALL CIRCUIT BREAKERS, FUSES AND ELECTRICAL EQUIPMENT SHALL HAVE AN INTERRUPTING RAT SHORT CIRCUIT CURRENT TO WHICH THEY MAY BE SUBJECTED, AND A MINIMUM OF 10,000 ALC.
- 17. THE ENTIRE ELECTRICAL INSTALLATION SHALL BE GROUNDED AS REQUIRED BY ALL APPLICABLE
- 18. RECEPTACLES SHALL BE 20 AMPERE, 125 VOLT A.C., WHITE AS REQUIRED BY THE ARCHITECT OR
- 19. WALL SWITCHES SHALL BE SINGLE-POLE, HUBBELL #1201 OR EQUIVALENT, WHITE AS REQUIRED B
- 20. PLASTIC PLATES FOR ALL SWITCHES, RECEPTACLES, TELEPHONE AND BLANKED OUTLETS, SHALL H WHERE INDICATED ON THE DRAWINGS. WEATHERPROOF RECEPTACLES SHALL HAVE RACO #800.
- 21. WIRE AND CABLE CONDUCTORS SHALL BE COPPER #12 AWG MINIMUM, NO BX OR ROMEX CA SPECIFICALLY NOTED OTHERWISE ON DRAWINGS.
- 22. GROUND RODS SHALL BE AS SPECIFIED ON THE GROUNDING DRAWINGS.
- 23. METER SOCKET AMPERES, VOLTAGE, NUMBER OF PHASES SHALL BE AS NOTED ON THE DRAWING SQUARE D COMPANY OR APPROVED EQUAL. IF HOST FACILITY REQUIRES THE NEW SERVICE TO B EXISTING SERVICE, SUB-METER SHALL BE OF THE 10x OR 16x TYPE.
- 24. ALL MATERIALS SHALL BE U.L. LISTED.
- 25. CONDUIT: A. SERVICE CONDUITS SHALL BE GRAY SCH.40 PVC BURIED MIN. 36", EXCEPT THAT SCH.80 SHALL B AND IN LOCATIONS SUBJECT TO CASUAL IMPACTS. BENDS SHALL BE MADE USING "WIDE SWEEP" HTITINGS. ANY CODE-REQUIRED RIGID STEEL CONDUIT SHALL BE ULL LABLE, GALVANIZED INSIDE / EXTEND MIN, 36" BELOW GRADE, WITH "SWEEP" ELBOWS (12" R, MIN,) ENDING IN PVC TRANSITION CONTACT WITH EARTH SHALL BE 1/2 LAP-WRAPPED WITH HUNTS PROCESS NO. 3 EXTENDING MIN
- B. INTERIOR CONDUITS SHALL BE ELECTRICAL METALLIC TUBING HAVING U.L. LABEL, FITTINGS SHAL COMPRESSION TYPE.
- C, FLEXIBLE METALLIC CONDUIT SHALL HAVE U.L. LISTED LABEL AND MAY BE USED WHERE PERMIT BE "JAKE" OR "SQUEEZE" TYPE, SEAL TIGHT FLEXIBLE CONDUIT. NO SUCH CONDUIT SHALL EXCEED
- 26. ALL ELECTRICAL EQUIPMENT SHALL BE LABELED WITH PERMANENT ENGRAVED PLASTIC LABELS.
- 27. PATCH, REPAIR, AND PAINT ANY AREA THAT HAS BEEN DAMAGED IN THE COURSE OF THE ELECT
- 28. PENETRATIONS IN FIRE RATED WALLS SHALL BE FIRE STOPPED IN ACCORDANCE WITH SECTION 7 INTERNATIONAL BUILDING CODE (IBC)
- 29. DRILLING OR CORING HOLES IN CONCRETE WALLS OR DECKS, WHETHER FOR FASTENING OR A REQUIRES THAT TENDONS OR REINFORCING STEEL MUST BE SEARCHED FOR BY APPROPRIATE MET OR OTHER DEVICE) THAT CAN ACCURATELY LOCATE THEM, TENDONS OR REINFORCING MUST IN DAMAGED UNDER ANY CIRCUMSTANCES.
- 30. UPON COMPLETION OF WORK, CONDUCT CONTINUITY, SHORT CIRCUIT, AND FALL POTENTIAL C APPROVAL. SUBMIT TEST REPORTS TO CONSTRUCTION ENGINEER, CLEAN PREMISES OF ALL DEBR AND LEAVE WORK IN A COMPLETE AND UNDAMAGED CONDITION.
- 31. CONTRACTOR TO COORDINATE WITH UTILITY COMPANY FOR CONNECTION OF BOTH TEMPOR. TO THE SITE. THE TEMPORARY POWER AND ALL HOOKUP COSTS TO BE PAID BY CONTRACTOR.
- 32. CONTRACTOR SHALL PROVIDE LABOR AND MATERIALS AS NECESSARY TO COMPLETE THE INST, LIGHTING SYSTEM DESCRIBED IN THE REQ.

GENERAL ELECTRICAL NOT

	verizon	
rk to be performed under Prior to the ordering of the Ten Notice of All findings to	JACOBBS Jacobs Engineering Group, Inc 2727 Patrion Road RoseVille, Minnesota 55113 www.jacobs.com	
RD, PULLBOX, J-BOX, SWITCH		
DNSTRUCTION TOOLS, DUGHOUT AND AS INDICATED		
AND SHALL BE OF THE BEST UIPMENT. MATERIALS SHALL BE I LABEL "J" WHERE SUBJECT TO FETY AND ALL GOVERNING APPLICABLE STANDARDS	Consulting Engineers, Inc. 2101 Highway 13 W Burnsville, MN 56337 608.644.1549 fax	
OUNTY AND LOCAL CODES	www.edgeconsult.com	
IOB ACCEPTANCE BY OWNER. DRRECTED AT ONCE,	PROJECT NO: 20171735332 LOCATION CODE: 484031 EDGE PROJECT NO: 18071	
" DRAWINGS AT THE	CHECKED BY: OGD	
D OVER TO OWNER AT JOB	REV. DATE DESCRIPTION INT. A 05/07/2018 PRELIM SMALL CELL DWGS ZRS B 05/15/2018 PRELIM SMALL CELL DWGS MWH	
ATING NOT LESS THE MAXIMUM	0 08/13/2018 FINAL SMALL CELL DWGS MWH	
E CODES AND DRAWINGS.		
≥ APPROVED EQUAL. BY THE ARCHITECT.		
HAVE ENGRAVED LETTERING 10, 1/2" RAISED WORK COVERS.		
ABLE IS PERMITTED UNLESS		
NGS. MANUFACTURED BY BE SUB-METERED FROM THE		
BE USED UNDER ROADWAYS ** (12° MIN, RADIUS) ELBOW AND OUTSIDE. CONDUIT SHALL NI FITTINGS. RIGID CONDUIT IN N. 12° ABOVE GRADE. ALL BE GLAND RING	APPROVED FOR	
TED BY CODE. FITINGS SHALL D SIX FEET IN LENGTH. 3.	St. C.	
CTRICAL WORK. 1712, PENETRATIONS -	I HEREBY CERTIFY THAT THIS PLAN, SPECFICATION,	
anchoring Purposes, Thods and Equipment (X-Ray Not be drilled, cut or	OR REPORT WAS PREPARED BY ME OR UNDER MY DIRECT SUPERVISION AND THAT I AM A DULY LICENSED PROFESSIONAL ENGINEER UNDER THE LAWS OF THE STATE OF MINNESOTA.	
GROUNDING TESTS FOR RIS RESULTING FROM WORK	DUL SUPER ONE SC1 3	
RARY AND PERMANENT POWER	DULUTH, MINNESOTA REPLACEMENT LIGHT POLE	
TALLATION OF ANY TOWER	SMALL CELL DRAWINGS	
	SHEET TITLE	
	SHEET NUMBER	
TES	E-101	



September 7, 2018

via FedEx: 7731 6661 9587

Mr. Steven Robertson City Planner | Community Planning City of Duluth 411 W. 1st Street, Room 208 Duluth, MN 55802

Re: Concurrent Use of Streets Permit Application Verizon Small Cell Sites: DUL Super One SC1-SC3

Dear Mr. Robertson,

Enclosed please find a Concurrent Use of Streets Permit Application for three Verizon Wireless small wireless facility installations. Two are collocations on Minnesota Power wood utility power poles in the right-of-way near the intersection of E. Superior St. and N. 60th Ave. E., and the third is a proposed collocation on a Minnesota Power wood light pole located near the intersection of E. Superior St. and Occidental Blvd. The purpose of these proposed small wireless facility installations is to address the data capacity and coverage in the area as well as addressing capacity issues during Grandma's Marathon and surrounding area that has heavy traffic during that event. Due to the equipment limitations for small wireless facility installations, three individual locations are required to achieve the necessary coverage objectives. A set of the design drawings for each of the proposed location contains the proposed distance between the antenna and the remote radio units to meet the Minnesota Power separation requirements.

It is important that cities like the City of Duluth encourage well-developed networks so that cellphones, tablets, and other "smart" devices will work properly when they are needed most. More than 50% of adults in the United States have only a wireless telephone with no traditional landline telephone service at all. That percentage will only rise as the next generation moves into adulthood, since more than 60% of children live in households that have a wireless phone as the only telephone. Here in the Midwest, 52.5% of adults live in households with no landline.¹ With these trends at work, wireless telephone users everywhere – including those in Duluth – require more cell sites to support the voice & data capabilities of their devices.


We look forward to working with the City to improve Verizon Wireless' wireless coverage in the community.


Sincerely,

Amy Dresch JACOBS | TELECOM |P: (612) 802-0452 |E: <u>amy.dresch@jacobs.com</u>

Enclosure

¹See U.S. Department of Health and Human Services, Centers for Disease Control and Prevention, Wireless Substitution: Early Release of Estimates from the National Health Interview Survey, January-June 2017(Dec. 2017) at p.1 available at https://www.cdc.gov/nchs/data/nhis/earlyrelease/wireless201712.pdf

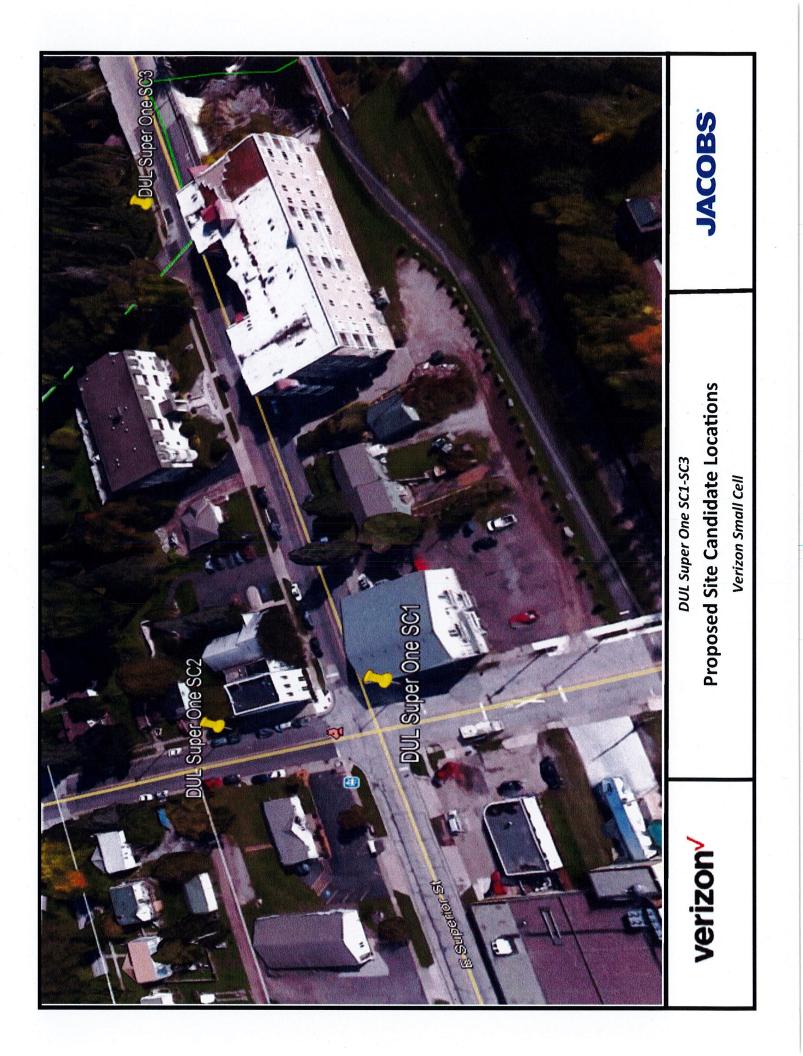

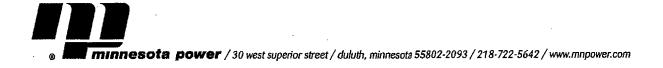

August 28, 2018

Mr. Steven Robertson City Planner | Community Planning City of Duluth 411 W. 1st Street, room 208 Duluth, MN 55802

Re: Verizon Wireless Small Cell Projects

DUL Spirit Mountain SC1 | MN Power Pole ID 14647195 | Alden Conversation 655239

DUL Super One SC1 | MN Power Pole ID 11329030 | Alden Conversation 655274

DUL Super One SC2 | MN Power Pole ID 11406260 | Alden Conversation 655286

DUL Super One SC3 | MN Power Pole ID 11329005 | Alden Conversation 655291

Dear Mr. Robertson,

As owner of the above referenced utility poles, we consent to allowing Verizon Wireless to apply for City permits for small cell wireless antennas and equipment on these poles.

As an attachment to our poles, Verizon will also be required to obtain an attachment permit from Minnesota Power and meet our attachment design standards.

Sincerely,

Shou

Jodi Corrow Distribution Assets Coordinator Sr. Minnesota Power



August 14, 2018

Mr. Steven Robertson, Senior Planner City of Duluth – Community Planning 411 W. 1st Street, Room 208 Duluth, MN 55802

Dear Mr. Robertson,

Cellular Inc. Network Corporation d/b/a Verizon Wireless is aware of the interference issues that can arise while co-locating with other carriers. In the event a collocation by an additional carrier is proposed, careful isolation studies will be performed to determine the correct vertical and horizontal separation between Verizon Wireless' antennas and any other carrier. This will avoid the possibility of our frequency interfering with other equipment. In addition, Verizon Wireless has acquired an FCC license, which exclusively entitles the company to operate within an assigned frequency range. This in turn eliminates any interference issues from CB radios, electronic appliances, pacemakers, fire and police equipment as well as other carriers. In the highly unlikely event that interference does occur, Verizon Wireless agrees to fully cooperate with the entity experiencing interference to identify and correct, to the extent reasonably possible, any issues caused by its installation.

Sincerely,

Michael Koch

Michael Koch RF Engineer – Northern MN Market

Optional Local Government Checklist (page 2)

EVALUATION OF CATEGORICAL EXCLUSION

12. Licensed Radio Service (see attached Table 1): Cellular Radiotelephone Service & Personal Communications Svc.

- 13. Structure Type (free-standing or building/roof-mounted): <u>Utility Pole</u>
- 14. Antenna Type [omnidirectional or directional (includes sectored)]: Panel/directional
- 15. Height above ground of the lowest point of the antenna (in meters): _____6.7056 meters (22 ft.) ____
- 16. \Box Check if <u>all</u> of the following are true:
 - (a) This facility will be operated in the Multipoint Distribution Service, Paging and Radiotelephone Service, Cellular Radiotelephone Service, Narrowband or Broadband Personal Communications Service, Private Land Mobile Radio Services Paging Operations, Private Land Mobile Radio Service Specialized Mobile Radio, Local Multipoint Distribution Service, or service regulated under Part 74, Subpart I (see question 12).
 - (b) This facility will <u>not</u> be mounted on a building (see question 13).
 - (c) The lowest point of the antenna will be at least 10 meters above the ground (see question 15).

If box 16 is checked, this facility is categorically excluded and is unlikely to cause exposure in excess of the FCC's guidelines. The remainder of the checklist need not be completed. If box 16 is not checked, continue to question 17.

- 17. Enter the power threshold for categorical exclusion for this service from the attached Table 1 in watts ERP or EIRP* (note: EIRP = (1.64) X ERP): (see below)
- 18. Enter the total number of channels if this will be an omnidirectional antenna, or the maximum number of channels in any sector if this will be a sectored antenna: (see below)
- 19. Enter the ERP or EIRP per channel (using the same units as in question 17): (see below)
- 20. Multiply answer 18 by answer 19: (see below)
- 21. Is the answer to question 20 less than or equal to the value from question 17 (yes or no)?

(see below)

If the answer to question 21 is YES, this facility is categorically excluded. It is unlikely to cause exposure in excess of the FCC's guidelines.

If the answer to question 21 is NO, this facility is not categorically excluded. Further investigation may be appropriate to verify whether the facility may cause exposure in excess of the FCC's guidelines.

^{17. 1000} ERP (700 MHz), 2000W ERP (1900 MHz/PCS, 2100 MHz/AWS)

^{18. 2} bands per block (LTE & AWS)

^{19. 365.72} ERP + 437.67 ERP (700 MHz + 850 MHz LTE) and 377.59 ERP + 377.59 ERP (2100 MHz AWS1 + AWS3)

^{20. 803.39} ERP (700 MHz + 850 MHz LTE) + 755.18 ERP (2100 MHz AWS1 + AWS3) = 1558.57 W ERP

^{21.} Yes

^{*&}quot;ERP" means "effective radiated power" and "EIRP" means "effective isotropic radiated power