

SITE NAME:

**DUL BURNING TREE PLAZA SC3** 

SITE NUMBER:

20181847132

LOCATION CODE:

504066

SITE TYPE:

SMALL CELL

INSTALLED BY

VERIZON

VEDIZON

FIBER PROVIDER

FIBER PROVIDER

VERIZON

VERIZON

VERIZON

VERIZON

VERIZON

NO:

G-001

G-002

G-003

N/A

C-101

C-102

C-501

T-201

T-501

T-502

S-001

S-501

E-101

E-102

E-103

F-501

E-502

INSTALLATION TYPE: REPLACEMENT LIGHT POLE

PROJECT DESCRIPTION/SOW

**WORK PRODUCT** 

ELECTRICAL CONDUIT. BETWEEN POLE BASE AND POWER SOURCE TO BE TRENCHED/DIRECTIONALLY BORED BELOW GRADE

FIBER CONDUIT, BETWEEN HAND HOLE AND POLE BASE, TO BE TRENCHED/DIRECTIONALLY BORED BELOW GRADE

FIBER CONDUIT, WITHIN RIGHT OF WAY, TO BE TRENCHED/DIRECTIONALLY BORED BELOW GRADE

ERICSSON RRUS AND POWER CONVERTERS

REPLACEMENT STEEL LIGHT POLE

CONCRETE POLE FOUNDATION

FIBER HAND HOLE AT POLE BASE

DIPLEXERS

LOAD CENTER

ELECTRICAL METER

GROUND RING AROUND POLE FOUNDATION

# SITE INFORMATION

### APPROXIMATE ADDRESS: 2247 MAPLE GROVE RD. DULUTH, MN 55806

# ST. LOUIS COUNTY SITE COORDINATES:

LAT: 46°-48'-26.86"N LONG: 92°-09'-59.89"W GROUND ELEVATION: 1318.9' AMSL (PER 1A CERTIFICATE)

# PRISMA BSBVE MAALI

REPLACEMENT POLE

# **LOCATION MAP**

# ALL WORK SHALL COMPLY WITH THE FOLLOWING APPLICABLE CODES:

**APPLICABLE CODES** 

- 2012 INTERNATIONAL BUILDING CODE - 2014 NATIONAL ELECTRIC CODE
- TIA/EIA-222-G OR LATEST EDITION

IN THE EVENT OF CONFLICT, THE MOST RESTRICTIVE CODE SHALL PREVAIL

# **LOCATION SCAN**



# Design finds of the state of th

# PROJECT DIRECTORY

### LESSEE:

VERIZON WIRELESS 10801 BUSH LAKE RD BLOOMINGTON, MN 55438 CONTACT: AMANDA TURNER PHONE: 612.720.1657

# ENGINEERING COMPANY: EDGE CONSULTING ENGINEERS, INC.

2101 HIGHWAY 13 W BURNSVILLE, MN 55337 CONTACT: OTTO DINGFELDER III PHONE: 952.683.1032

### SITE ACQUISITION:

JACOBS ENGINEERING GROUP, INC. 2727 PATTON ROAD ROSEVILLE, MN 55113 CONTACT: AMY DRESCH PHONE: 952.831.1043

### JINEC I ON I

# LESSOR: CITY OF DULUTH 411 W 1ST ST DULUTH, MN 55802 PHONE: 218.730.5000

# RE ENGINEER: VERIZON WIRELESS 10801 BUSH LAKE RD BLOOMINGTON, MN 55438 CONTACT: MICHAEL KOCH

# 11"x17" PLOT WILL BE HALF SCALE UNLESS OTHERWISE NOTED

\*\* REVIEWED AND APPROVED BY STRUCTURAL ENGINEER

SHEET INDEX

SHEET TITLE

TITLE SHEET & PROJECT DATA

GENERAL SPECIFICATIONS

GENERAL SPECIFICATIONS

ENLARGED SITE PLAN

SITE ELEVATION

UTILITY PLAN

UTILITY PLAN

COMPLETED BY OTHERS

ANTENNA DETAILS

EQUIPMENT DETAILS

STRUCTURAL NOTES \*

GROUNDING PLAN

GROUNDING DETAILS

UTILITY DETAILS

STRUCTURAL DETAILS \*\*

TRAFFIC CONTROL PLANS

SUDVEY

SITE PLAN

CONTRACTOR SHALL VERIFY ALL PLANS AND EXISTING DIMENSIONS/CONDITIONS ON SITE. IMMEDIATELY NOTIFY ENGINEER OF ANY DISCREPANCIES PRIOR TO PERFORMING ANY WORK OR BE RESPONSIBLE FOR THE SAME.

# ENGINEER OF RECORD

EDGE CONSULTING ENGINEERS, INC. CONTACT: OTTO DINGFELDER III (PE # 49720 (MN)) PHONE: 608.644.1449

# STRUCTURAL REVIEW

STRUCTURAL ANALYSIS COMPLETED BY: EDGE CONSULTING ENGINEERS, INC. PROJECT #: 20096 DATE: 08/21/2018

CONTRACTOR TO REVIEW STRUCTURAL REPORT IN ITS ENTIRETY.
ANY DISCREPANCIES OR DISAGREEMENTS BETWEEN THE REPORT
AND THESE PLANS SHOULD BE RESOLVED PRIOR TO CONSTRUCTION



# **JACOBS**



2101 Highway 13 W Burnsville, MN 55337 608.644.1449 voice 608.644.1549 fax

PROJECT NO:	20181847132
LOCATION CODE:	504066
EDGE PROJECT NO:	20096

OGD

CHECKED BY:

REV.	DATE	DESCRIPTION	INT.
Α	08/29/2018	PRELIM SMALL CELL DWGS	JMk
0	09/10/2018	FINAL SMALL CELL DWGS	JM
1	10/08/2018	FINAL SMALL CELL DWGS	JM
		·	
			$\vdash$




DUL BURNING TREE PLAZA SC3 DULUTH, MN REPLACEMENT LIGHT POLE SMALL CELL DRAWINGS

SHEET TITLE

TITLE SHEET & PROJECT DATA

SHEET NUMBER

G-001

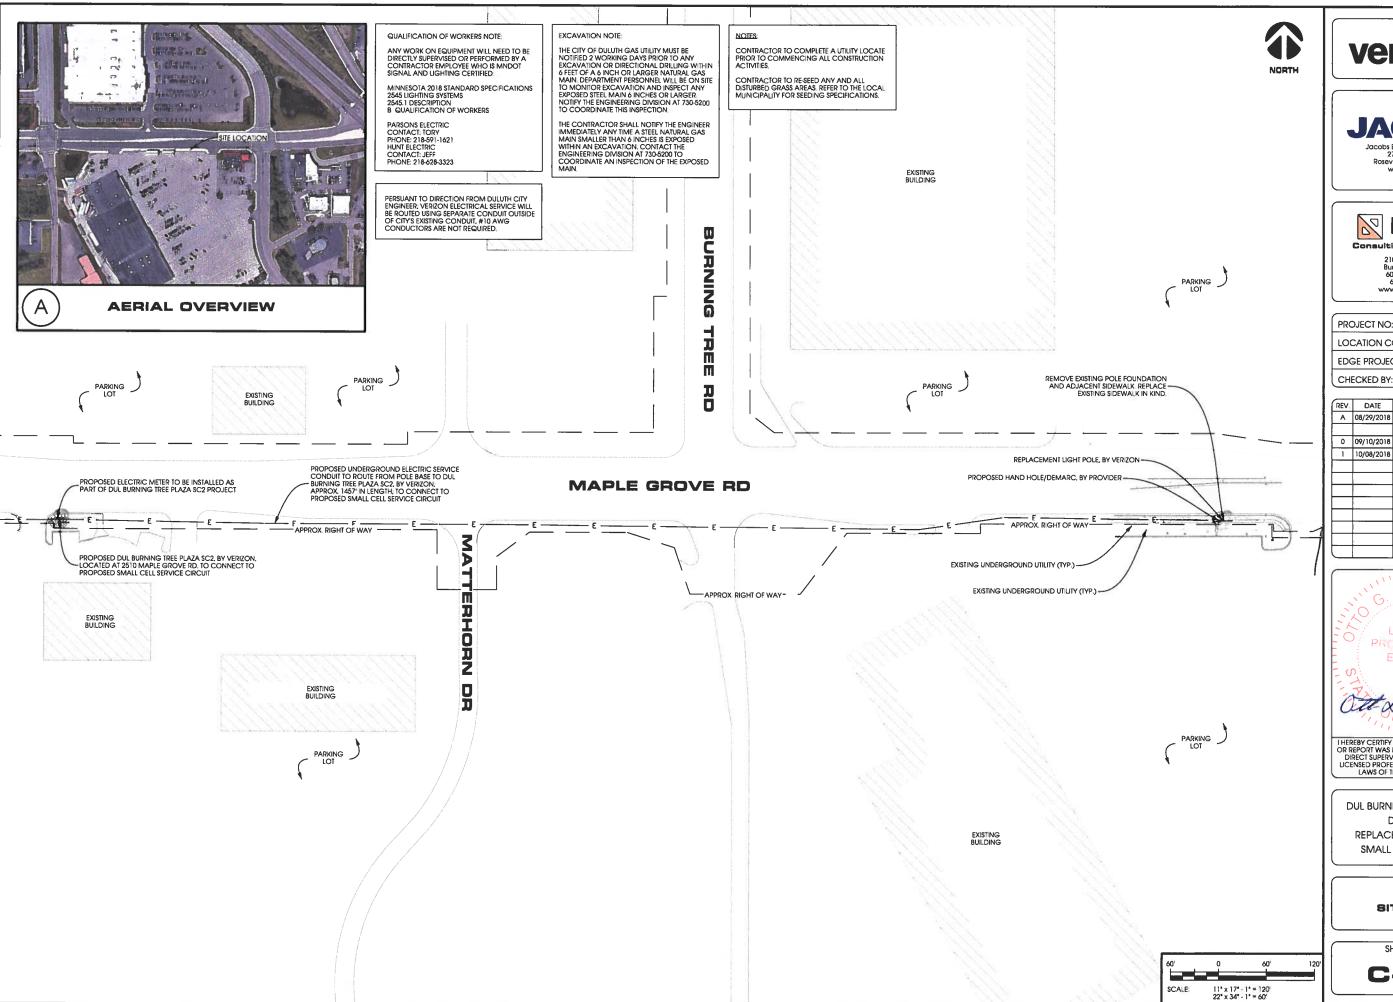



# **JACOBS**

Jacobs Engineering Group, Inc 2727 Patton Road Roseville, Minnesota 55113 www.jacobs.com




nsulting Engineers, In

2101 Highway 13 W Burnsville, MN 55337 608.644.1449 voice 608.644.1549 fax www.edgeconsult.com

	PROJECT NO:	20181847132
	LOCATION CODE:	504066
'	EDGE PROJECT NO:	20096
	CHECKED BY:	OGD

- 1					
	И	REV.	DATE	DESCRIPTION	INT.
	П	Α	08/29/2018	PRELIM SMALL CELL DWGS	JMK
	П				
-	П	0	09/10/2018	FINAL SMALL CELL DWGS	JMK
		1	10/08/2018	FINAL SMALL CELL DWGS	JMK
- 1	П				
i					
	П				
	П				
-1	H				
-1	П				

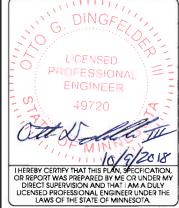

DUL BURNING TREE PLAZA SC3
DULUTH, MN

REPLACEMENT LIGHT POLE SMALL CELL DRAWINGS

SHEET TITLE

SITE PLAN

SHEET NUMBER

C-101



# EXCAVATION NOTE:

THE CITY OF DUILUTH GAS UTILITY MUST BE NOTIFIED 2 WORKING DAYS PRIOR TO ANY EXCAVATION OR DIRECTIONAL DRILLING WITHIN 6 FEET OF A 6 INCH OR LARGER NATURAL GAS MAIN. DEPARTMENT PERSONNEL WILL BE ON SITE TO MONITOR EXCAVATION AND INSPECT ANY EXPOSED STEEL MAIN 6 INCHES OR LARGER NOTIFY THE ENGINEERING DIVISION AT 730-5200 TO COORDINATE THIS INSPECTION

THE CONTRACTOR SHALL NOTIFY THE ENGINEER IMMEDIATELY ANY TIME A STEEL NATURAL GAS MAIN SMALLER THAN 6 INCHES IS EXPOSED WITHIN AN EXCAVATION CONTACT THE ENGINEERING DIVISION AT 730-5200 TO COORDINATE AN INSPECTION OF THE EXPOSED MAIN.

# NORTH



# **JACOBS**

Jacobs Engineering Group, Inc 2727 Patton Road Roseville, Minnesota 55113 www.jacobs.com



Consulting Engineers, Inc.

2101 Highway 13 W Burnsville, MN 55337 608.644.1449 voice 608.644.1549 fax www.edaeconsult.com

PROJECT NO:	20181847132
LOCATION CODE:	504066
EDGE PROJECT NO:	20096

CHECKED BY: OGD

RE	V.	DATE	DESCRIPTION	INT.
A	\	08/29/2018	PRELIM SMALL CELL DWGS	JMK
C	)	09/10/2018	FINAL SMALL CELL DWGS	JMK
1		10/08/2018	FINAL SMALL CELL DWGS	JMK

# DINGFE LICENSED PROFESSIONAL ENGINEER 49720 MINGFE MINGFE DINGFE AND A COURT

I HEREBY CERTIFY THAT THIS PLAN. SPECFICATION, OR REPORT WAS PREPARED BY ME OR UNDER MY DIRECT SUPERVISION AND THAT I AM A DULY LICENSED PROFESSIONAL ENGINEER UNDER THE LAWS OF THE STATE OF MINNESOTA.

DUL BURNING TREE PLAZA SC3

DULUTH, MN

REPLACEMENT LIGHT POLE

SMALL CELL DRAWINGS

SHEET TITLE


ENLARGED SITE PLAN

SHEET NUMBER

C-102

# **MAPLE GROVE RD**



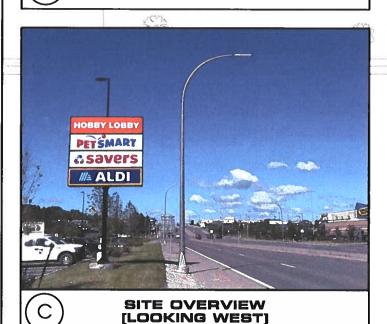


PROPOSED VAIDERGROUND ELECTRIC SERVICE
CONDUIT OF ROUTE PROVIDE BASE TO DUIL
APPROX. LAZE? IN LENGER 1, O CONNECT TO
PROPOSED SMALL CELL SERVICE CIRCUIT


PROPOSED SMALL CELL SERVICE CIRCUIT

PROPOSED FIRER OPTIC SERVICE CONDUIT
TO DOUTE WITHIN INCHT OF WAY BY
PROPOSED FIRER OPTIC SERVICE CONDUIT
TO DOUTE WITHIN INCHT OF WAY BY
PROPOSED FIRER OPTIC SERVICE CONDUIT
OF DOUTE SERVICE CONDUIT TO ROUTE SERVICE
CONDUIT TO ROUTE SERVICE
CONDUIT TO ROUTE SERVICE
CONDUIT TO RO

5' 0 5' 10' SCALE: 11° x 17° - 1° = 10' 22° x 34° - 1° = 5'

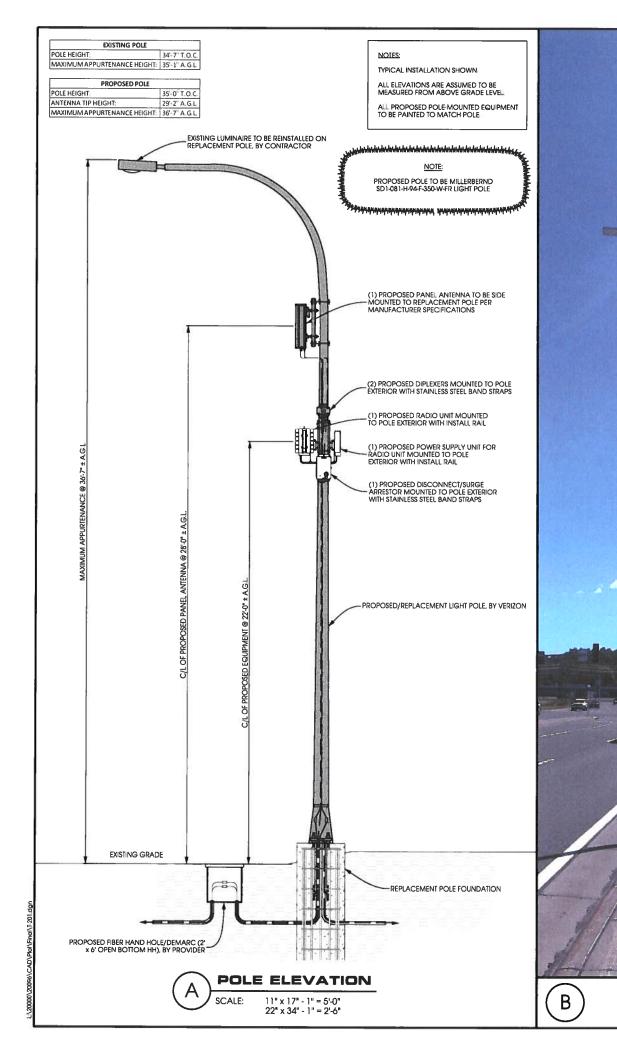



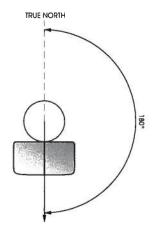

ANTENNA ORIENTATION
SCALE; NTS

ANTENNAS					
QUANTITY MAKE		MODEL CENTERLINE		TIP HEIGHT AZIMUT	
1	ANDREW	HBXX-6513DS-A2M	28'-0"' AGL	29'-2" AGL	180 *

EQUIPMENT					
QUANTITY	TYPE	MAKE	MODEL		
1	RRU	ERICSSON	RRU\$8843		
1	PSU	ERICSSON	PSU 6302		
2	DIPLEXER	COMMSCOPE	CBC1923T-4310 E11F13PO6		

CABLING				
QUANTITY	TYPE	MAKE	MODEL	
12	COAX	COMMSCOPE	F4-HMDM-1M-D	

ANTENNA AND CABLING
SCALE: NTS





SITE ELEVATION

Penershtling Antonsviral
Radio Instocking Nation Sergond (side point
Mark EXCERD IN PICC Occupational
Experient Linds.
Congruent Linds.
Cost Institution Sergond Institution and Institution
Penership Sergond Institution Institution Penership Sergond Institution Penership Sergond (Nat point).





E RF WARNING SIGNS
SCALE: NTS



# **JACOBS**


Jacobs Engineering Group, Inc 2727 Patton Road Roseville, Minnesota 55113 www.jacobs.com



2101 Highway 13 W Burnsville, MN 55337 608.644.1449 voice 608.644.1549 fax www.edgeconsult.com

PROJECT NO:	20181847132
LOCATION CODE:	504066
EDGE PROJECT NO:	20096
CHECKED BV:	OGD

REV.	DATE	DESCRIPTION	INT,
Α	08/29/2018	PRELIM SMALL CELL DWGS	JMK
0	09/10/2018	FINAL SMALL CELL DWGS	JMK
1	10/08/2018	FINAL SMALL CELL DWGS	JMK
		-	

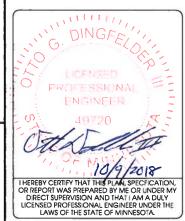

DUL BURNING TREE PLAZA SC3

DULUTH, MN

REPLACEMENT LIGHT POLE


SMALL CELL DRAWINGS

SHEET TITLE

SITE ELEVATION

SHEET NUMBER

T-201

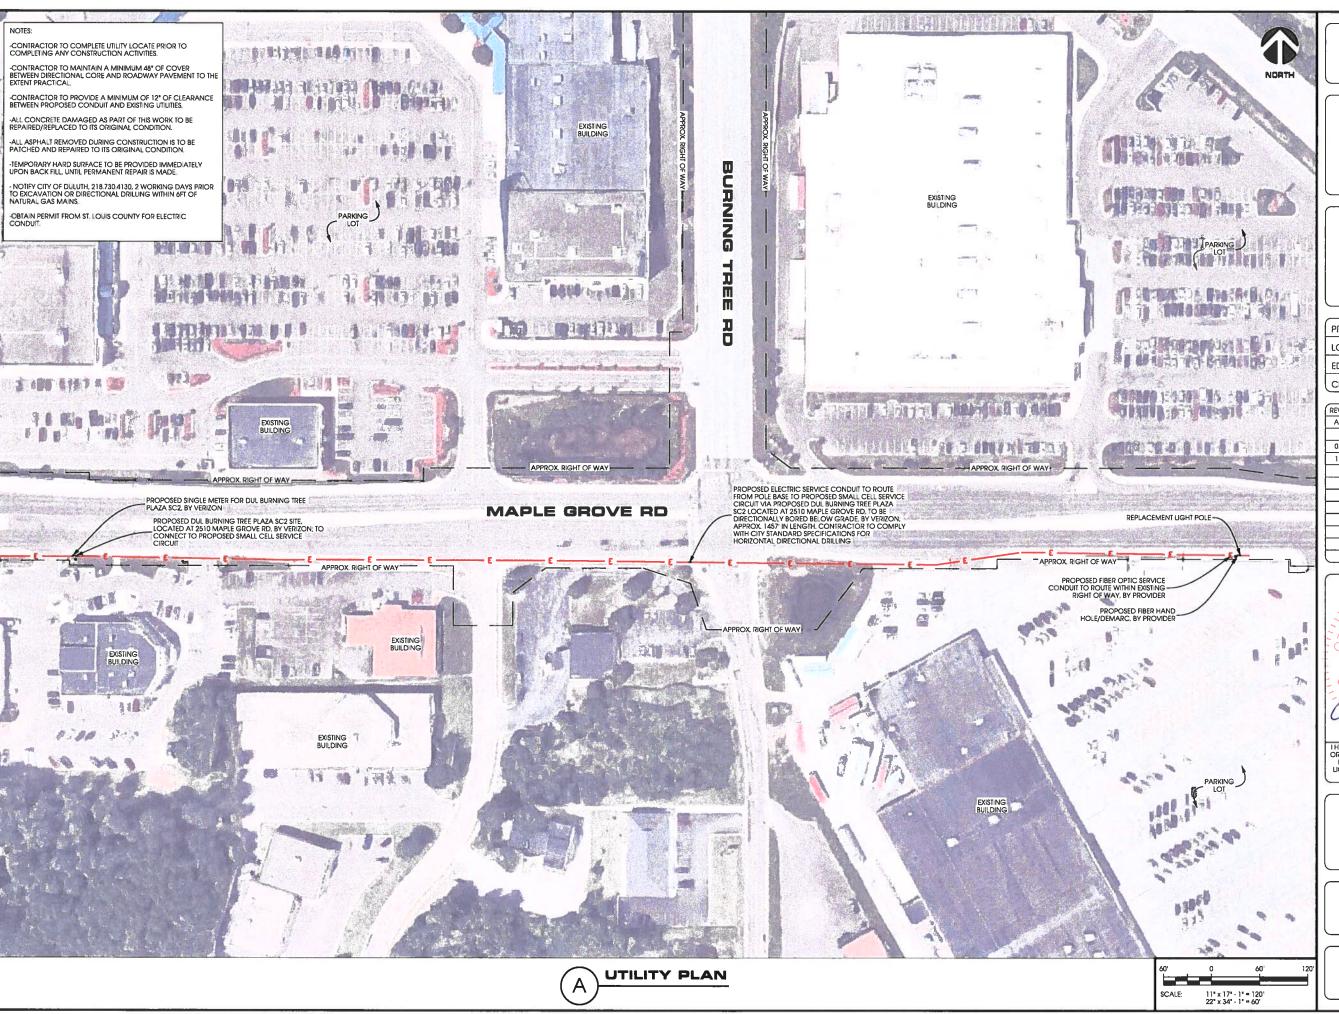



# **JACOBS**

Jacobs Engineering Group, Inc 2727 Patton Road Roseville, Minnesota 55113 www.jacobs.com




2101 Highway 13 W Burnsville, MN 55337 608,644,1449 voice 608,644,1549 fax www.edgeconsulf.com

PROJECT NO: 20181847132 LOCATION CODE: 504066

EDGE PROJECT NO: 20096
CHECKED BY: OGD

REV	DATE	DESCRIPTION	INT.
Α	08/29/2018	PRELIM SMALL CELL DWGS	JMK
0	09/10/2018	FINAL SMALL CELL DWGS	JMK
1	10/08/2018	FINAL SMALL CELL DWGS	JMK
		•	
	1		

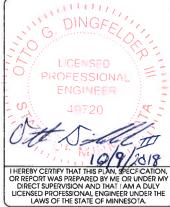

DUL BURNING TREE PLAZA SC3 DULUTH, MN

REPLACEMENT LIGHT POLE SMALL CELL DRAWINGS

SHEET TITLE

UTILITY PLAN

SHEET NUMBER

E-101